# Agenda Planning Commission City Of Edina, Minnesota City Hall, Council Chambers

#### Wednesday, November 16, 2022 7:00 PM

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#### **Enter Conference Pin 4691667#**

Press \*1 on your telephone keypad when you would like to get in the queue to speak

An operator will introduce you when it is your turn

- I. Call To Order
- II. Roll Call
- III. Approval Of Meeting Agenda
- IV. Approval Of Meeting Minutes
  - A. Draft Minutes of Regular Meeting October 25, 2022
- V. Community Comment


During "Community Comment," the Board/Commission will invite residents to share relevant issues or concerns. Individuals must limit their comments to three minutes. The Chair may limit the number of speakers on the same issue in the interest of time and topic. Generally speaking, items that are elsewhere on tonight's agenda may not be addressed during Community Comment. Individuals should not expect the Chair or Board/Commission Members to respond to their comments tonight. Instead, the Board/Commission might refer the matter to staff for consideration at a future meeting.

#### VI. Public Hearings

- A. B-22-19 and B-22-20: 3517 & 3601 55th Street West-Lot Width Variances
- B. B-22-21: A 9.55 foot front yard setback and a 9.6 foot 1st floor height variance request for 4905 Sunnyslope Rd
- VII. Chair And Member Comments
- VIII. Staff Comments

#### IX. Adjournment

The City of Edina wants all residents to be comfortable being part of the public process. If you need assistance in the way of hearing amplification, an interpreter, large-print documents or something else, please call 952-927-8861 72 hours in advance of the meeting.

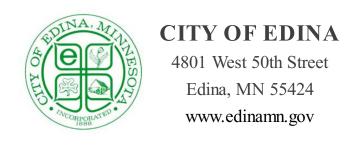

**Date:** November 16, 2022 **Agenda Item #**: IV.A.

To: Planning Commission Item Type:

Minutes

Action

From: Liz Olson, Administrative Support Specialist

**Item Activity:** 

Subject: Draft Minutes of Regular Meeting October 25, 2022

#### **ACTION REQUESTED:**

Approve the draft minutes from October 25, 2022.

#### **INTRODUCTION:**

#### **ATTACHMENTS:**

Draft Minutes from October 25, 2022



# Minutes City Of Edina, Minnesota Planning Commission Edina City Hall Council Chambers October 25, 2022

#### I. Call To Order

Chair Agnew called the meeting to order at 7:02 PM.

#### II. Roll Call

Answering the roll call were: Commissioners Miranda, Strauss, Alkire, Bennett, Padilla, and Chair Agnew. Staff Present: Cary Teague, Community Development Director, and Liz Olson, Administrative Support Specialist.

Absent from the roll call: Commissioner Gandhi, Hu, Olson and Smith.

#### III. Approval Of Meeting Agenda

Commissioner Padilla moved to approve the October 25, 2022, agenda. Commissioner Miranda seconded the motion. Motion carried unanimously.

#### IV. Approval Of Meeting Minutes

A. Minutes: Planning Commission, September 28, 2022 and October 12, 2022

Commissioner Miranda moved to approve the September 28, 2022 and October 12, 2022, meeting minutes. Commissioner Strauss seconded the motion. Motion carried unanimously.

#### V. Community Comment

None.

Commissioner Bennett joined the meeting at 7:16 PM.

#### VI. Public Hearings

#### A. Site Plan Review and Ordinance Amendment - 4901 West 77th Street

Director Teague presented the request of 4901 West 77<sup>th</sup> Street for a Site Plan review and Ordinance Amendment. Staff recommended approval of the Site Plan review and Ordinance Amendment, as requested subject to the findings and conditions listed in the staff report.

Staff answered Commission questions.

#### **Appearing for the Applicant**

Mr. Jay Scott, Salmon Real Estate Group, Mr. Scott Laugen, First Bank and Trust, and Kyle Peterson, HTG Architects, made a presentation to the Commission and answered questions.

#### **Public Hearing**

None.

Commissioner Miranda moved to close the public hearing. Commissioner Padilla seconded the motion. Motion carried unanimously.

The Commission discussed the proposed site plan and provided the following feedback:

- Loved the enclosed drive through
- Liked the design of the building and is very striking
- Great incorporation of landscaping

#### <u>Motion</u>

Commissioner Alkire moved that the Planning Commission recommend approval to the City Council of the site plan and ordinance amendments as outlined in the staff memo subject to the conditions and findings therein. Commissioner Strauss seconded the motion. Motion carried 5 ayes, I nay (Miranda).

#### B. Subdivision with Lot Area, Width and Depth Variances - 6146 McCauley Circle

Director Teague presented the request of 6146 McCauley Circle for a subdivision with lot area, width and depth variances. Staff recommends approval of the subdivision with lot area, width and depth variances, as requested subject to the findings and conditions listed in the staff report.

Staff answered Commission questions.

#### **Appearing for the Applicant**

Mr. Dipendra Mahaseth, 6416 McCauley Circle owner, and Brianna Olsen, Realtor, addressed the Commission and answered questions.

#### **Public Hearing**

Mr. Michael Smith, 6445 McCauley Terrace, addressed the Commission and indicated his opposition to the proposed variances.

Mr. Kevin Crudden, 6720 Indian Hills Road, addressed the Commission and indicated he was not in favor of these variances.

Mr. Brett Parmenter, 6443 McCauley Terrace, addressed the Commission and explained his opposition to the proposed variances.

Mr. Michael Ramme, 6401 McCauley Circle, addressed the Commission and stated he was against this proposed variance.

Commissioner Miranda moved to close the public hearing. Commissioner Bennett seconded the motion. Motion carried unanimously.

The Commission discussed the proposed subdivision with variances and provided the following feedback:

- Interesting lot with two potential entrances on two different cul-de-sac's
- History in the area of rezoning.
- A subdivision needs to maintain the character of the neighborhood, this does not do that.
- This neighborhood is known for larger lots and should not be subdivided.
- Support creating additional opportunities for families to live in Edina.
- There are near adjacent lots of similar or smaller size with some much larger.
- Concerned about incremental environmental damage to the lake by having two buildings rather than one building.
- Recommend requiring the conservation steps staff mentioned.
- Variety of lot sizes and shapes in the area.
- The character of the neighborhood is changing

#### Motion

Commissioner Alkire moved that the Planning Commission recommend approval to the City Council of the subdivision with variances as outlined in the staff memo subject to the conditions and findings therein and a conservation easement be established from the top of the steep slope to the lakeshore preventing tree removal, disturbance of the slopes, no manicured lawns, and no structures in the easement. To be in place prior to the City Council approving the final plat. Commissioner Padilla seconded the motion. Motion carried 5 ayes, I nay (Bennett).

#### IX. Chair and Member Comments


Received.

#### X. Staff Comments

Received

#### XI. Adjournment

Commissioner Miranda moved to adjourn the October 25, 2022, Meeting of the Edina Planning Commission at 8:28 PM. Commissioner Strauss seconded the motion. Motion carried unanimously.

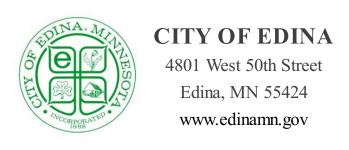

**Date:** November 16, 2022 **Agenda Item #**: VI.A.

To: Planning Commission Item Type:

Report and Recommendation

From: Kris Aaker, Assistant City Planner & Emily Bodeker,

Assistant City Planner Item Activity:

**Subject:** B-22-19 and B-22-20: 3517 & 3601 55th Street West-

Lot Width Variances

#### **ACTION REQUESTED:**

Two separate motions, one for each property.

Approve the lot width variance as requested at 3517 55th Street West based on the findings and conditions listed in the staff report.

Approved the lot width variance as requested at 3601 55th Street West based on the findings and conditions listed in the staff report.

#### **INTRODUCTION:**

Sustainable 9 Design Build is requesting two, 15-foot lot width variances for a pair of vacant 60-foot-wide lots located south of west 55<sup>th</sup> Street and backing up to Minnehaha Creek at 3601 and 3517 West 55<sup>th</sup> Street. A previous homeowner separated the lots and obtained individual addresses and PID numbers for Lot 1 – 3601 W 55<sup>th</sup> Street, (15,260 sq ft in area) and Lot 4 – 3517 W 55<sup>th</sup> Street, (14,812 sq ft in area). The lots are owned individually/separate owners. The previous home has been removed from the site with both lots vacant and poised for new home construction. Conforming home plans for each lot are proposed and are permit ready. The two lots conform to the minimum R-1 lot size requirements with the exception of width.

#### ATTACHMENTS:

Staff Report: 3517 & 3601 55th Street West

Applicant Submittal-3517 55th Street West

Engineering Memo-3517 55th Street West

Applicant Submittal-3601 55th Street West

Engineering Memo- 3601 55th Street West

Additional Information from Applicants
Site Location Map
Better Together Public Hearing Comment Report
Staff Presentation

#### STAFF REPORT



Date:

November 16, 2022

To:

Planning Commission

From:

Emily Bodeker/Kris Aaker, Assistant City Planners

Subject:

15-foot Lot Width Variances – 3601 and 3517 West 55th Street

#### Information / Background:

Sustainable 9 Design Build is requesting two, 15-foot lot width variances for a pair of vacant 60-foot-wide lots located south of west 55<sup>th</sup> Street and backing up to Minnehaha Creek at 3601 and 3517 West 55<sup>th</sup> Street. A previous homeowner separated the lots and obtained individual addresses and PID numbers for Lot I – 3601 W 55<sup>th</sup> Street, (15,260 sq ft in area) and Lot 4 – 3517 W 55<sup>th</sup> Street, (14,812 sq ft in area). The lots are owned individually/separate owners. The previous home has been removed from the site with both lots vacant and poised for new home construction. Conforming home plans for each lot are proposed and are permit ready. The two lots conform to the minimum R-I lot size requirements with the exception of width. The following are the minimum ordinance requirements for lot size in the R-I, Single Dwelling Unit zoning district:

Sec. 36-437. - Requirements for lot areas and dimensions.

Minimum lot width: **75 feet** Minimum lot depth: 120 feet

Minimum lot area: 9,000 square feet

To accommodate the requests, the following are required:

A 15-foot Lot Width Variance for: Lot I – 3601 W 55th Street

A 15-foot Lot Width Variance for: Lot 4 – 3517 W 55th Street.

#### **Surrounding Land Uses**

Surrounding lots contain single-family residential homes and are Zoned R-I, single dwelling unit district.

#### **Planning**

Guide Plan designation: Single-dwelling residential Zoning: R-1, Single-dwelling district

#### **Lot Dimensions**

	Area	Lot Width	Depth	Street Frontage
REQUIRED	9,000 s.f.	75 feet	I 20 feet	30 feet
Lot I – 3601 55th	15,260 s.f.	60 feet*	254 feet	60 feet
Lot 4 – 3517 55th	14,812 s.f.	60 feet*	234 feet	60 feet

<sup>\*</sup>Variance Required

#### Tree Removal

The city recently amended its tree ordinance to require that removed trees be replaced. The ordinance does not take effect until January I, 2023. However, because there are variances being requested, and to minimize impacts to the neighborhood, staff would recommend a condition of approval be that the new ordinance must be met, with trees being replaced on the site per recommendation of the City Forester.

#### **Engineering**

The Engineering Department has reviewed the subject properties located at 3601 and 3517 W 55<sup>th</sup> Street for street and utility concerns, grading, stormwater, erosion and sediment control and for general adherence to the relevant ordinance sections. Plans reviewed included a stormwater management plan and report, existing and proposed surveys.

Stormwater was reviewed and is consistent with City of Edina Building Policy SP-003 standards. A final grade as-built survey and inspection will be required to verify compliance with the approved stormwater plan for both properties.

The FEMA 1% annual chance floodplain is located in the rear yard of both lots, with a lowest floor elevation required at no less than 2 feet above the base flood elevation. Both properties comply with low floor requirements.

#### **Proposed Site Features**

Sustainable 9 Design Build has sold Lot-4, at 3517 West 55<sup>th</sup> Street to Andrew and Brandy Morris who intend to have Sustainable 9 build a new single-family home on their lot. Building plans are attached for the address, are permit ready and conform to all zoning ordinance requirements as indicated on the following compliance table:

#### Compliance Table-3517 West 55th Street

	City Standard	Proposed
North Side –		\
Front Yard	37.6 feet	40 feet
West Side –		
Side Yard	12 feet total, with no less than 5 feet on one side	6 feet
South Side –		
Rear Yard	50 feet from OHWM	Greater than 50 feet
East Side – Side Yard	12 feet total, with no less than 5 feet on one side	6.2 feet
Building Height	30 feet	29.42 feet
Building Coverage	25%	23.18%
Impervious Surface Coverage	50%	40.98%

First Floor Elevation	876.4	872.56
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The remaining Lot-1, at 3601 West 55th Street is still owned by Sustainable 9 Design Build and a new single family spec home has been designed to be built on the lot conforming to all zoning ordinance requirements as indicated on the following compliance table:

#### Compliance Table-3601 West 55th Street

	City Standard	Proposed
North Side – Front Yard	37.6 feet	\ 42.6 feet
West Side – Side Yard	12 feet total, with no less than 5 feet on one side	6 feet
South Side – Rear Yard	50 feet from OHWM	Greater than 50 feet
East Side – Side Yard	12 feet total, with no less than 5 feet on one side	6.6 feet
Building Height	30 feet	26.5 feet
Building Coverage Lots greater than 9,000sf	25%	15.83%
Impervious Surface Coverage	50%	22.85%
First Floor Elevation	876.4	875.2

#### **Primary Issues**

#### Are the findings for lot width variances met?

Yes. Staff believes that the findings for lot width Variances are met.

Per state law and the Zoning Ordinance, a variance should not be granted unless it is found that the enforcement of the ordinance would cause practical difficulties in complying with the zoning ordinance and that the use is reasonable. As demonstrated below, staff believes the proposal meets the variance standards, when applying the three conditions:

## a) Will the proposal relieve practical difficulties that prevent a reasonable use from complying with the ordinance requirements?

Yes. Reasonable use does not mean that the applicant must show the land cannot be put to any reasonable use without the variance. Rather, the applicant must show that there are practical difficulties in complying with the code and that the proposed use is reasonable. "Practical difficulties" may include functional and aesthetic concerns.

The practical difficulty is caused by the current ordinance requiring a 75-foot lot width that was amended after the underlying plat was originally established with 60-foot lot widths. The two individual lots have separate ownership. Conforming homes have been designed for each property and can be built without requesting additional variances from the zoning ordinance. The minimum 75-foot lot width requirement is a practical difficulty preventing each lot owner reasonable use of their property.

## b) There are circumstances that are unique to the property, not common to every similarly zoned property, and that are not self-created?

The circumstances unique to this property, are the size and shape of the lots that were not created by the applicant. Both lots have individual PID numbers, separate addresses and are owned by different parties. Variances are only needed to resolve lot widths for both properties, which are an existing condition that was not self-created by the applicant or property owners.

#### c) Will the variance alter the essential character of the neighborhood?

No. The proposed improvements requested by the variances would not alter the essential character of the neighborhood. Two new compliant single-family homes will be constructed on the lots that have similar widths as other properties in the neighborhood.

#### **Approval**

Recommend the Planning Commission approve the proposed Lot Width Variances for each property. Approval is based on the following findings:

- 1. Lots within this area were consistently platted with 60-foot widths prior to the current requirement of 75 feet.
- 2. The lots exceed the lot depth and area requirements and are similar to other lots within this area, including width.

3. The practical difficulty is caused by the current ordinance lot width minimum. The 60-foot-

wide lots were originally platted prior to the current 75-foot lot width minimum.

4. The 60-foot-wide lots are reasonable in context with neighboring property. Each lot is individually owned with an address and PID number for each lot with variances from the lot

width allowing for new home construction which is a reasonable use of each lot.

5. House plans are proposed for each lot requiring no additional variances and will not alter

the essential character of the neighborhood.

**Staff Recommendation** 

Staff recommends individual approval of the following lot width variances subject to the findings and

conditions listed above:

A 15-foot lot width variance for 3601 West 55th Street, (Lot-1), PID 2002824220118

A 15-foot lot width variance for 3517 West 55th Street, (Lot-4), PID 2002824220119

Approval shall be subject to the following conditions:

Subject to Surveys submitted for both properties date stamped October 14, 2022.

Compliance with the Engineering memos for each property date stamped October 28,

2022.

Compliance with the newly adopted tree ordinance, with all replacement trees planted on

site.

**Deadline for a City Decision:** December 14, 2022


#### 3517 W 55th St, Edina, MN 55410 - PID 2002824220119

#### **VARIANCE APPLICATION:**

SUMMARY: A double wide lot of 120ft wide with one single family home was split into two new legal parcels each at 60ft wide by the previous homeowner and purchased as such by Sustainable 9 Design Build. Sustainable 9 Design Build has since sold one of the new lots (3517 W 55th St, Edina, MN 55410 with PID 2002824220119) to our clients who intend to build a new single family home, Andrew and Brandy Morris. The remaining lot (3601 W 55th St, Edina, MN 55410 with PID 2002824220118) is still owned by S9 and a new single family spec home has been designed. A demolition permit was already pulled and the old existing home has been removed.

ISSUE: The standard allowable width for new Edina lots is 75ft. Both of these new lots are only 60ft wide. Thus, we have been informed only recently that the lot split (which Sustainable 9 had been told was complete at the time of the original land purchase) will not be deemed official and complete until a variance is filed and approved.

PROPOSAL: We believe this variance should be approved primarily because it corrects an extraordinary circumstance and the result is more in keeping with the essential character of the neighborhood then what was there previously. All of the adjacent neighbors and vast majority of the surrounding neighborhood is set at 60ft or less for their lot width. At our neighborhood meeting for the demolition, the neighbor to the east of the two lots in question noted his support of this variance, Eric Michael at 3511 55th St W, Edina, MN 55410 with PtD 2002824220108. We all believe this variance would create a cohesive street of nice homes on 60ft wide lots.

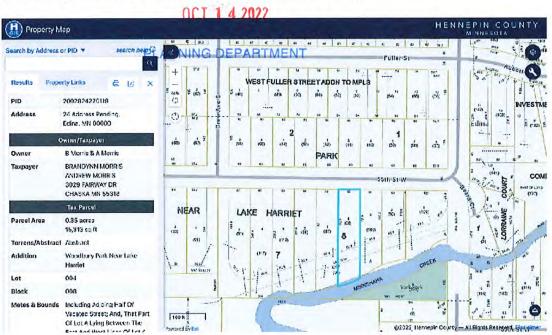





# MORRIS RESIDENCE

for ANDREW & BRANDY MORRIS 3517 WEST 55TH ST EDINA, MN 55410 1 4 2022

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VARIANCE SUBMITTAL


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UNFOLD ARCHITECTURE

**ORRIS RESIDENCE** 

SHEET NAME
COVER SHEET

A O O

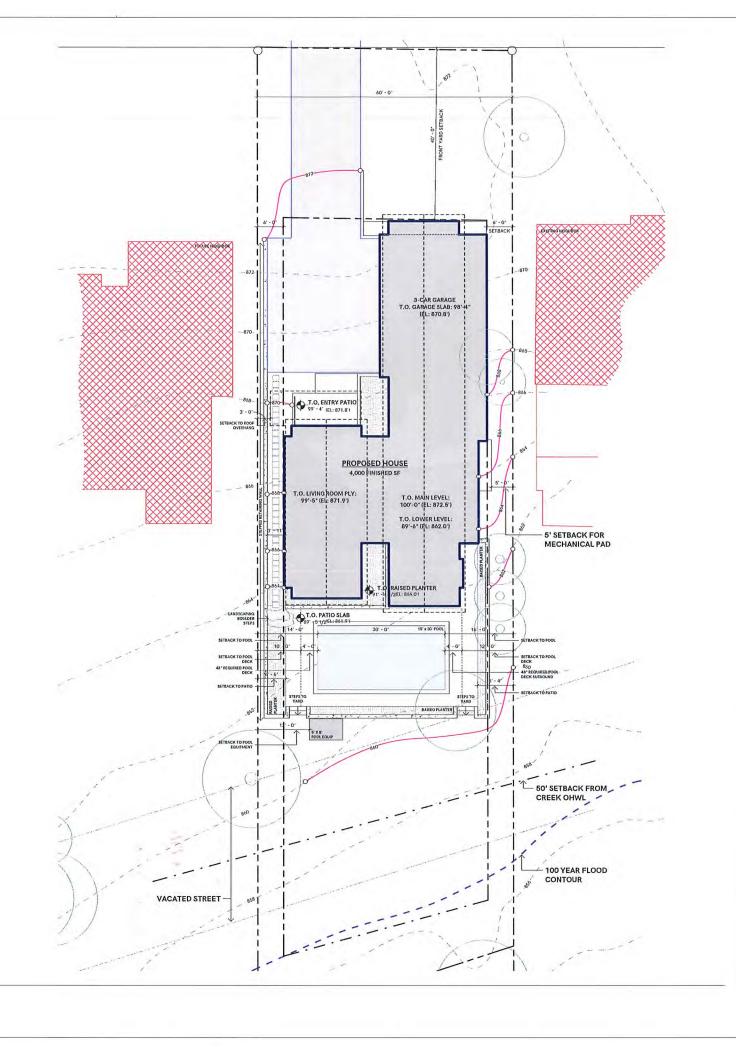

#### SITE PLAN LEGEND



PROPOSED ACCESSORY STRUCTURE

763,486,7779 www.unfoldarchitecture.com

SPACE RESERVED FOR AHD STAM

UNFULD ARCHITECTURE

CONSULTING





CIVIL ENGINEER & SURVEYOR:

DEMARC LAND SURVEYING & ENG. 7501 73RD AVE NI. WWW.DEMARCING.COM

# MORRIS RESIDENCE 3517 WEST 55TH ST EDINA, MN 55410

PROJECT NUMBER 2207 SHEET NAME ARCHITECTURAL SITE PLAN

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**ZONING INFORMATION** 

LANDSCAPED AREA

SILT FENCING

TOTAL LOT AREA: 14,812 SF

**BUILDING COVERAGE:** ALLOWABLE (25%):

3,703.50 SF ACTUAL: (23.18%): 3,434.00 SF

HARDCOVER: ALLOWABLE (50%): ACTUAL (40.98%)

7,406.00 SF 6,070.00 SF - BUILDING FOOTPRINT: 2,583.00 SF - ADDITIONAL HARDSCAPE: 3,487.00 SF

MAX BUILDING HEIGHT:

ALLOWABLE: ACTUAL: AVG. EXTG GRADE:

**LOWER LEVEL CALCULATION** 

TOTAL LINEAR FEET OF WALL:

203 LF

2,162.0 SF

(56%)

30.0 29.5

870'

Measuring from Top of Lower Level Slab to Top of Main Level Ply

- 40' Linear Feet @ 11' 8 3/4" (11.73') = 469.2 SF - 33' Linear Feet @ 9'-11" (9.92') = 327.4 SF - 130' Linear Feet @ 10'-6" (10.5') = 1,365.0 SF

TOTAL SURFACE AREA OF WALL:

SURFACE AREA BELOW GRADE: 1,210.2 SF

SURFACE AREA ABOVE GRADE:


951.8 SF (44%)



NOTE: ARCHITECTURAL SITE PLAN IS SCHEMATIC ONLY. REVIEW RESIDENCE LOCATION, SITE SETBACKS, GRADING, AND APPLICABLE LOCAL CODES WITH A LICENSED CIVIL ENGINEER.

ARCHITECTURAL SITE PLAN

1° = 10'-0"

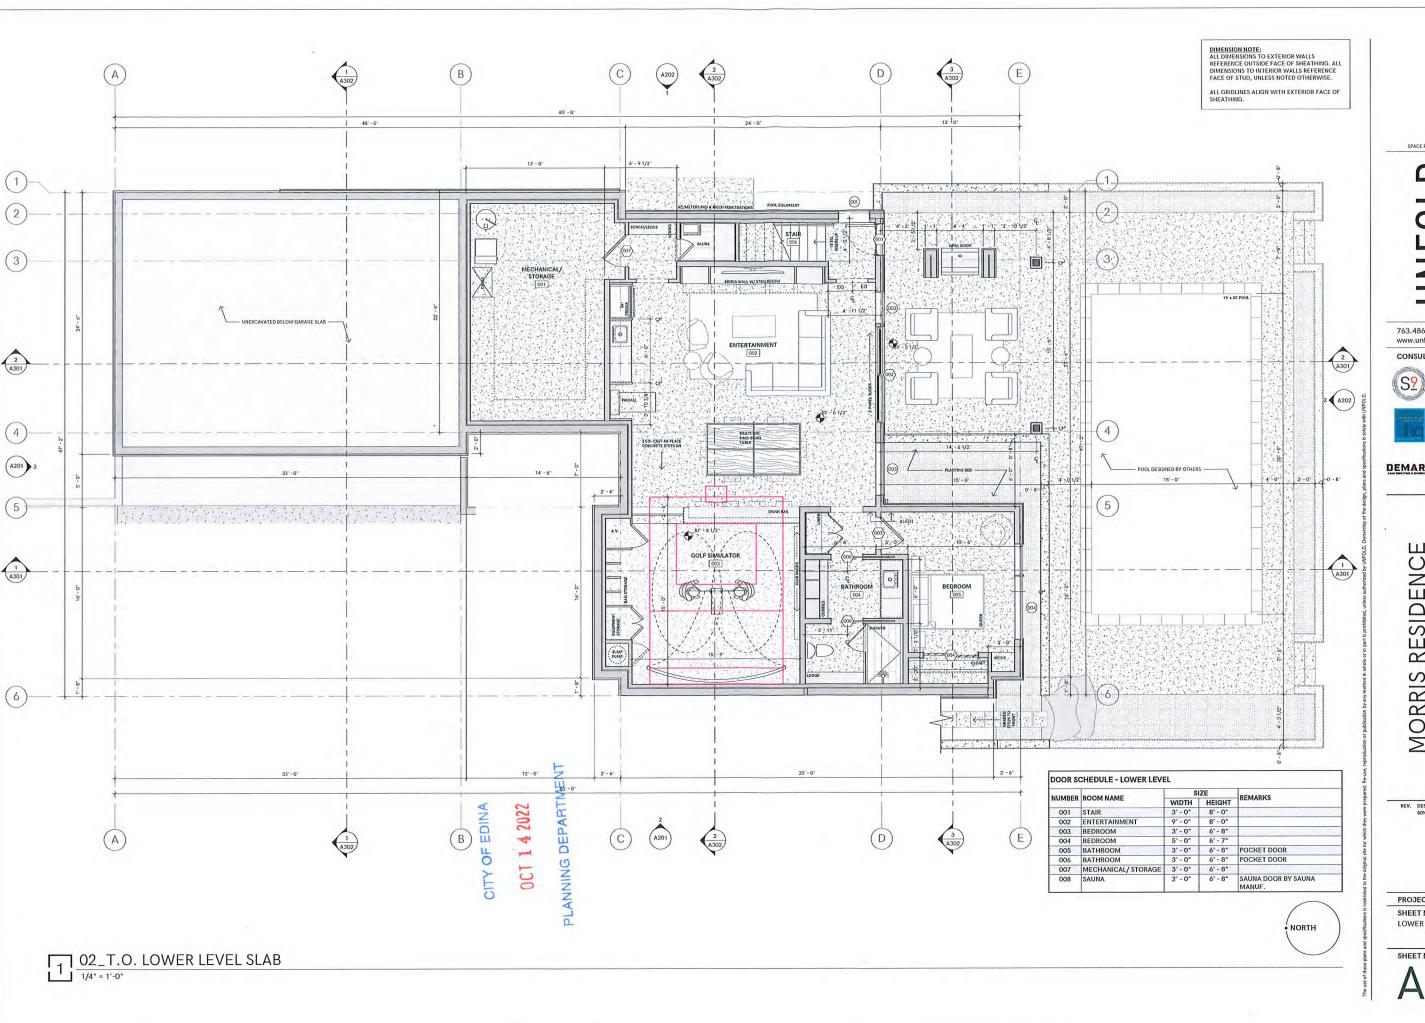

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DEMARC

CIVIL ENGINEER & SURVEYOR:


DEMARC LAND SURVEYING & ENG. 7601 73RD AVE N. MINNEAPOLIS, MN 55428 WWW.DEMARCING.COM

MORRIS RESIDENCE 3517 WEST 55TH ST EDINA, MN 55410

REV. DESCRIPTION 50% CD's DATE 09/21/2022

PROJECT NUMBER 2207

SHEET NAME LOWER LEVEL FLOOR PLAN

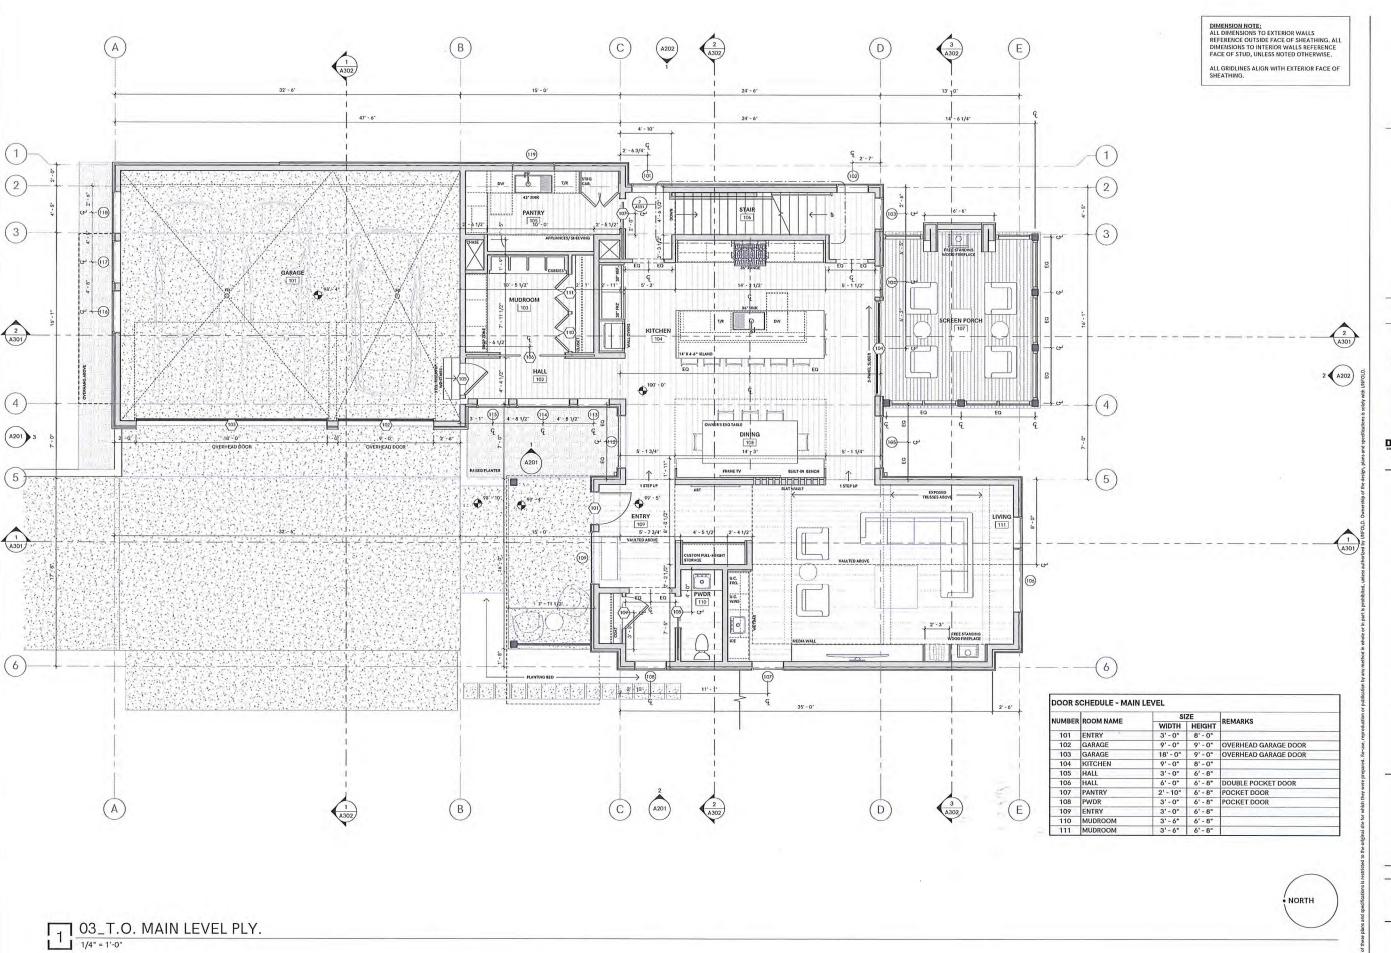

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SUSTAINABLE 9 DESIGN + BUILD
3511 W 44TH STREET
MINNEAPOUS, MM 55410
WWW.SUSTAINBLE9.COM

STRUCTURAL ENGINEER:
THE HAISON GROUP
3407 KILMER LANE NORTH
PLYMOUTH, MN 55446

DEMARC

CIVIL ENGINEER & SURVEYOR:

DEMARC LAND SURVEYING & ENG.
7601 73RD AVE N.
MINNEAPOLIS, MN 55428
WWW.DEMARCING.COM

MORRIS RESIDENCE 3517 WEST 55TH ST EDINA, MN 55410

REV. DESCRIPTION DATE 50% CD's 09/21/2022


PROJECT NUMBER
SHEET NAME

2207

MAIN LEVEL FLOOR PLAN

SHEET NUMBER

A102

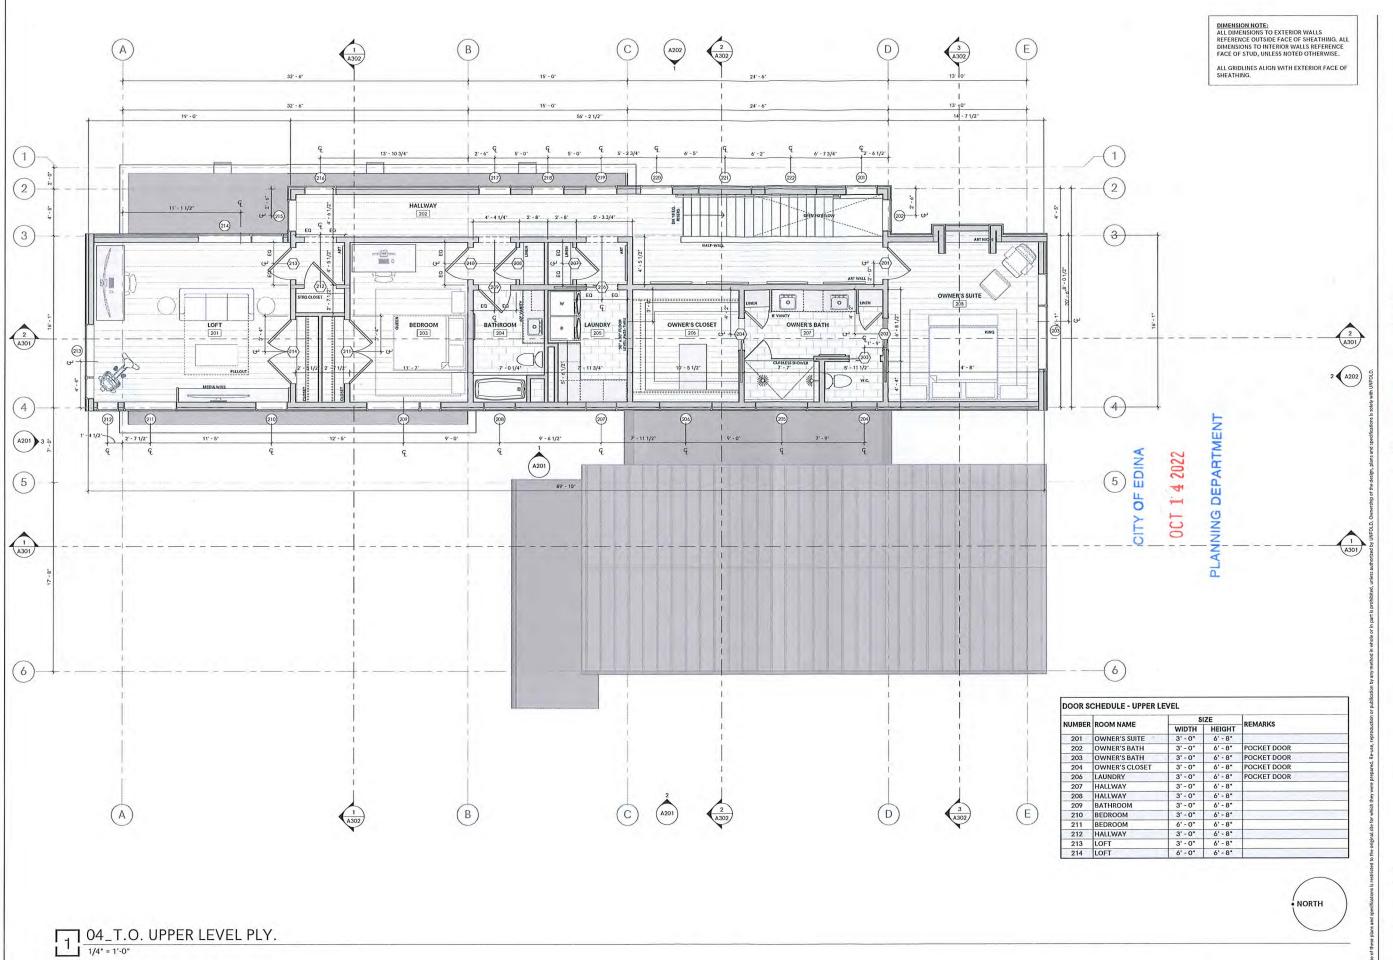

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SUSTAINABLE 9 DESIGN + BUILD 3511 W 44TH STREET MINNEAPOLIS, MN 55410 WWW.SUSTAINBLE9.COM

STRUCTURAL ENGINEER:

THE HANSON GROUP 3407 KILMER LANE NORTH PLYMOUTH, MN 55446 WWW. HANSONGROUPMN C

DEMARC

CIVIL ENGINEER & SURVEYOR:

DEMARC LAND SURVEYING & ENG 7601 73RD AVE N. MINNEAPOLIS, MN 55428 WWW.DEMARCING.COM


MORRIS RESIDENCE 3517 WEST 55TH ST EDINA, MN 55410

REV. DESCRIPTION 50% CD's DATE 09/21/2022

PROJECT NUMBER

2207

SHEET NAME UPPER LEVEL FLOOR PLAN

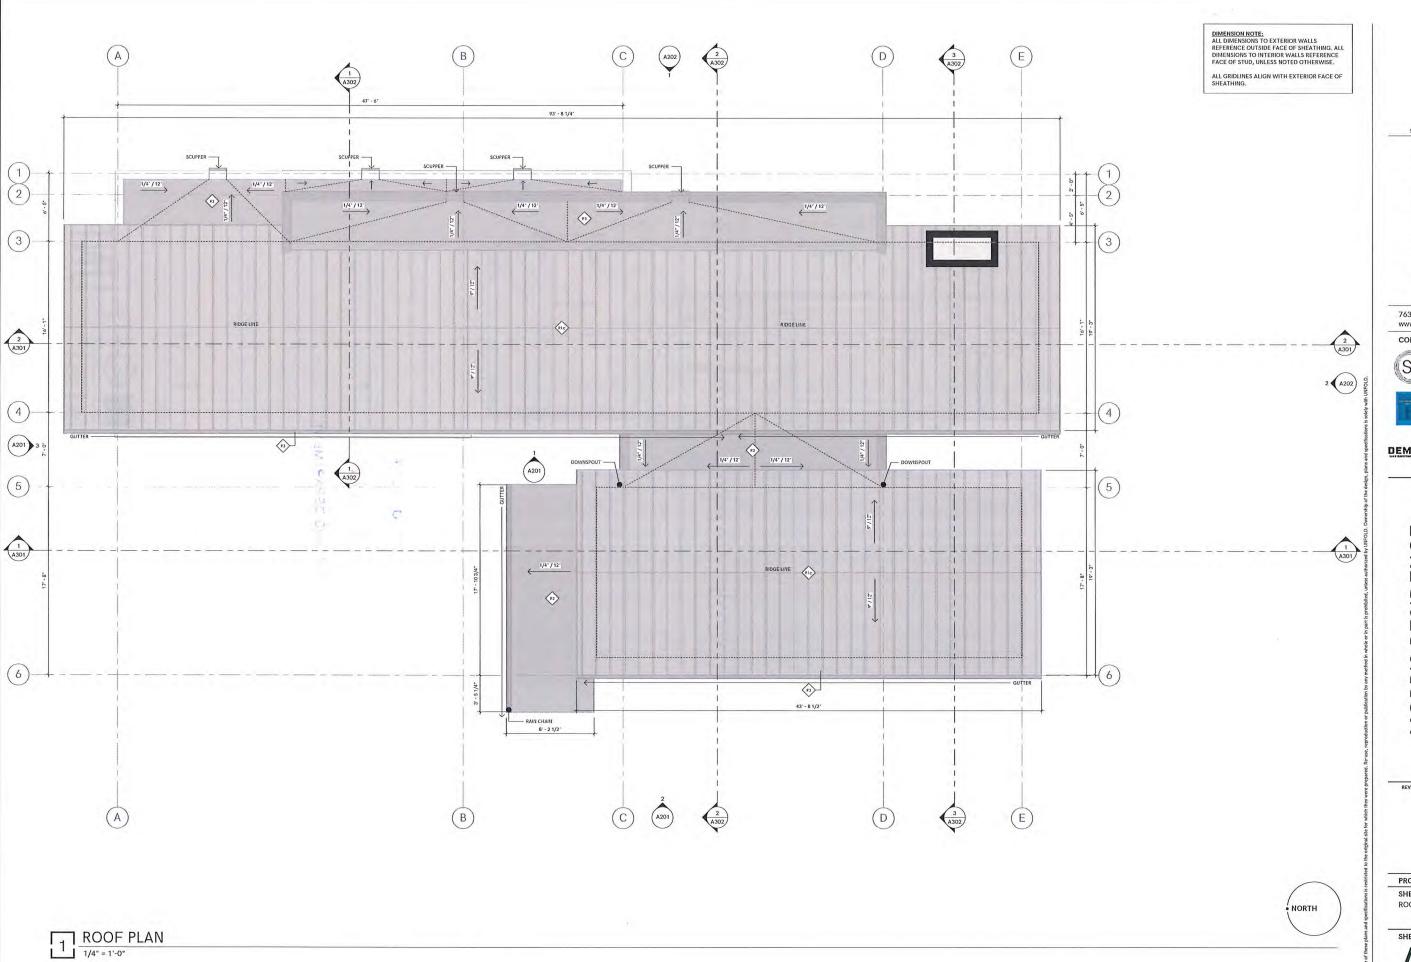

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STRUCTURAL ENGINEER: CIVIL ENGINEER & SURVEYOR:

DEMARC

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MORRIS RESIDENCE 3517 WEST 55TH ST EDINA, MN 55410

PROJECT NUMBER 2207

SHEET NAME ROOF LEVEL PLAN





EXTERIOR ELEVATION - EAST

3/16" = 1'-0"

MATERIAL KEYNOTE LEGEND KEYVALUE MATERIAL DESCRIPTION LIGHT STUCCO HARDIE PANELING (DARK FINISH) WOOD LOOK SIDING STONE VENEER (LIGHT FINISH) STANDING SEAM METAL ROOFING (DARK FINISH) SCREEN PORCH CONCRETE RETAINING WALL TIMBER POST & BEAM CONSTRUCTION DARK PREFINISHED METAL DOWNSPOUT/GUTTER DARK PREFINISHED MINIMAL METAL SCUPPER. TYPICAL PREFINISHED METAL COPING (DARK FINISH) 2x6 HARDIE FASCIA BOARD (DARK FINSIH) POWDER COATED CHIMNEY SHROUD (DARK FINISH) CAST-IN-PLACE CONCRETE PORCH WOOD SLAT SCREEN WALL PREFINISHED METAL OVERHEAD GARAGE DOORS (DARK FINISH) STEPPED CONCRETE PAVERS ADDRESS SIGNAGE ON WOOD PANELING

SPACE RESERVED FOR AHJ STAMP

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SUSTAINABLE 9 DESIGN + BUILD 3511 W 44TH STREET MINNEAPOLIS, MN 55410 WWW.SUSTAINBLE9.COM



THE HANSON GROUP 3407 KILMER LANE NORTH PLYMOUTH, MN 55446

CIVIL ENGINEER & SURVEYOR DEMARC LAID SURVEYING & ENG. 7601 738D AVE N. MINISAPOLIS, MMI 5542B WWW.DEMARCINC.COM

MORRIS RESIDENCE 3517 WEST 55TH ST EDINA, MN 55410

REV. DESCRIPTION

DATE 09/21/2022

PROJECT NUMBER 2207

SHEET NAME EXTERIOR ELEVATIONS



3517 WEST 55TH STREET

3601 WEST 55TH STREET

PLANNING DEPARTMENT

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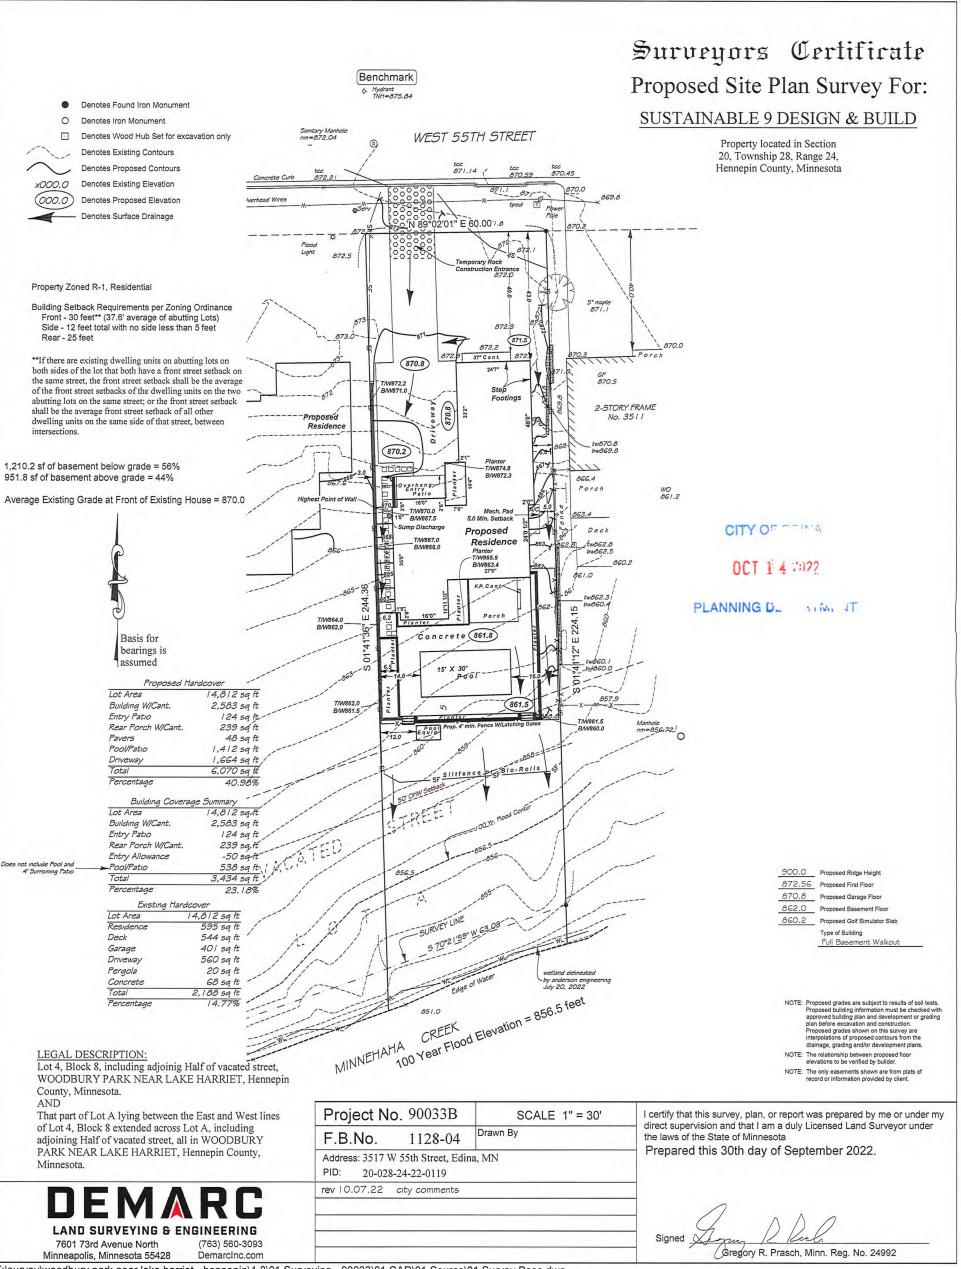
MORRIS RESIDENCE 3517 WEST 55TH ST EDINA, MN 55410


PROJECT NUMBER 2207

SHEET NAME RENDERING

#### Surveyors Certificate Existing Conditions Survey For: SUSTAINABLE 9 DESIGN & BUILD Property Zoned R-1, Residential Building Setback Requirements per Zoning Ordinance Property located in Section Front - 30 feet\*\* (37.6' average of abutting Lots) Side - 12 feet total with no side less than 5 feet 20, Township 28, Range 24, Hennepin County, Minnesota Rear - 25 feet Basis for 3517 W 55th St bearings is \*\*If there are existing dwelling units on abutting lots on both assumed sides of the lot that both have a front street setback on the Benchmark same street, the front street setback shall be the average of the Denotes Found Iron Monument front street setbacks of the dwelling units on the two abutting lots on the same street; or the front street setback shall be the Denotes Iron Monument average front street setback of all other dwelling units on the **Denotes Existing Contours** same side of that street, between intersections. WEST 55TH STREET ® PIM=872.04 Denotes Existing Elevation tcc tcc 870.59 870.45 tcc 872.84 873.0 V -N 89°02'01" E 60,00 872.5 872.7872.6 872.9 39.5 873.0 873.2 872.3873.2 873.8 orch 875.3 2-STORY FRAME 2-STORY FRAME No. 3601 No. 3511 2-STORY FRAME 870.9 No. 3605 869.7 870. 869.9 Deck WO 861.2 Deck 36 865.0 861.0 244. 870 8 Ш 26" pine 861.5 860.3 863.3 Manhole rım=856.72 856.9-CITY OF EDINA 855.3 OCT 1 4 2022 100 Yr. 854.6 PLANNING DEPART 853.0 859.3 wetland delineated by anderson engineering July 20, 2022 100 Year Flood Elevation = 856.5 feet 855.6 Lot Area 14,812 sq ft 595 sq ft Residence Deck 544 sq ft Garage 401 sq ft 851.0 1,540 sq ft Total LEGAL DESCRIPTION: Percentage Lot 4, Block 8, including adjoinig Half of vacated street, WOODBURY PARK NEAR LAKE HARRIET, Hennepin The only easements shown are from plats of record or County, Minnesota. information provided by client. AND That part of Lot A lying between the East and West lines Project No. 90033 I certify that this survey, plan, or report was prepared by me or under my SCALE 1" = 30' of Lot 4, Block 8 extended across Lot A, including direct supervision and that I am a duly Licensed Land Surveyor under adjoining Half of vacated street, all in WOODBURY 1128-04 the laws of the State of Minnesota F.B.No. PARK NEAR LAKE HARRIET, Hennepin County, Surveyed this 6th day of July 2022. Address Pending, Edina, MN Address: Minnesota. PID No.: 20-028-24-22-0119 rev 08.8.22 wetland delineation 7601 73rd Avenue North


Gregor R. Prasch, Minn. Reg. No. 24992



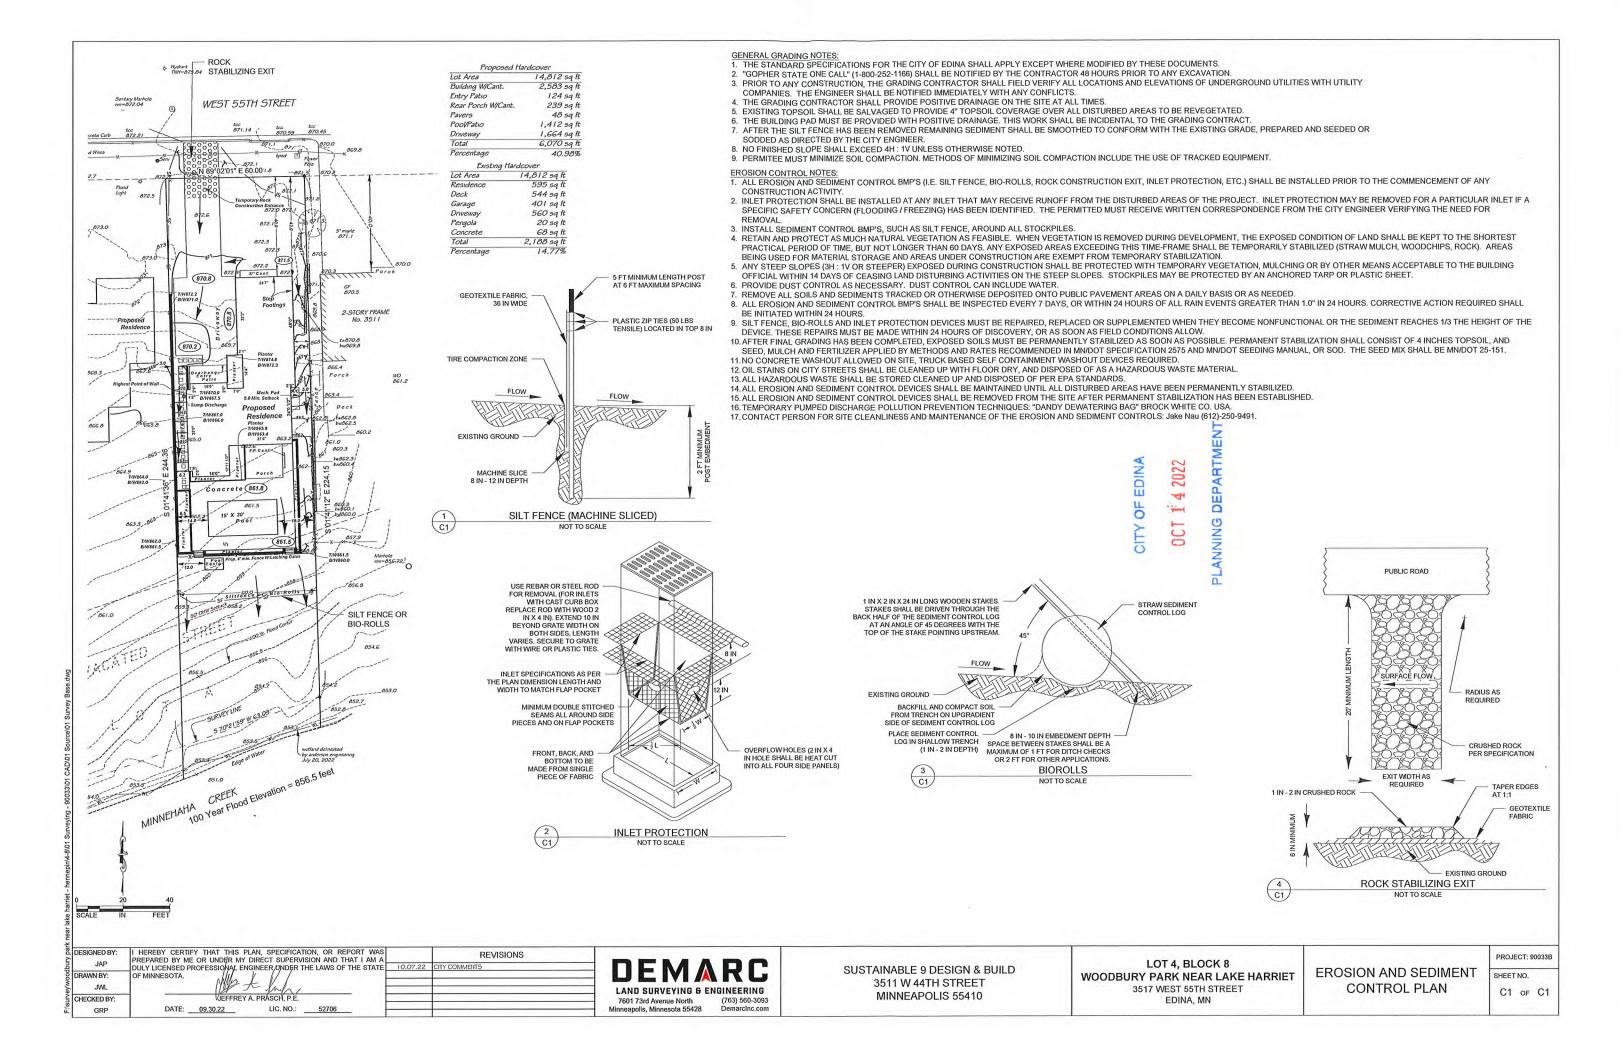

Tree Removals Tree # To be Removed To Be Preserved To Be Replaced Surveyors Certificate 3 36" Silver Maple 8 20" Spruce 9 17" Spruce Tree Preservation Plan For: 026" Pine ① 9" Pine ① 25" Pine ③ 15" Pine SUSTAINABLE 9 DESIGN & BUILD (14) 14" Pine (15) 14" Crab Property located in Section 20, Township 28, Range 24, Hennepin County, Minnesota Basis for bearings is assumed Benchmark Denotes Found Iron Monument Denotes Iron Monument Sanitary Manhole **Denotes Existing Contours** rim=872.04 Denotes Existing Elevation tcc tcc 870.59 870.45 tcc 872.84 Denotes Tree To Be Removed tcc 873.07 873.0 Valle 02'01" E 60.0071.8 Light 872.5 872.9 872. 873.0 873.2 872.3 873.0 870.0 870.5 No. 360 2-STORY FRAME No. 3605 AC 869. Proposed Residence WO 867.1 85665.8 365.0 \$66.2 863.5 CITY OF EDINA NON-REPLACEMENT TREE SETBACK LINE (T 855.3 OCT 1 4 2022 854.6 PLANNING DEPARTMEN 860.8 859.3 Manhole rim=857.81 Property Zoned R-1, Residential 100 Year Flood Elevation = 856.5 feet Building Setback Requirements per Zoning Ordinance Front - 30 feet\*\* (37.6' average of abutting Lots) Side - 12 feet total with no side less than 5 feet Rear - 25 feet \*\*If there are existing dwelling units on abutting lots on both sides of the lot that both have a front street setback on the same street, the front street setback shall be the average 851.0 of the front street setbacks of the dwelling units on the two LEGAL DESCRIPTION: abutting lots on the same street; or the front street setback Lot 4, Block 8, including adjoinig Half of vacated street, shall be the average front street setback of all other WOODBURY PARK NEAR LAKE HARRIET, Hennepin dwelling units on the same side of that street, between County, Minnesota. The only easements shown are from plats of record or intersections. AND information provided by client. That part of Lot A lying between the East and West lines Project No. 90033A I certify that this survey, plan, or report was prepared by me or under my SCALE 1" = 30' of Lot 4, Block 8 extended across Lot A, including direct supervision and that I am a duly Licensed Land Surveyor under adjoining Half of vacated street, all in WOODBURY Drawn By F.B.No. the laws of the State of Minnesota 1128-04 PARK NEAR LAKE HARRIET, Hennepin County, Surveyed this 6th day of July 2022. Address: 3517 West 55th Street, Edina, MN Minnesota. 20-028-24-22-0119 rev 10.13.22 tree removals 7601 73rd Avenue North (763) 560-3093 Gregory R. Prasch, Minn. Reg. No. 24992 Minneapolis, Minnesota 55428 DemarcInc.com F:\survey\woodbury park near lake harriet - hennepin\4-8\01 Surveying - 90033\01 CAD\01 Source\01 Survey Base.dwg

# \*TREE PLAN SUBMITTED AND APPROVED FOR DEMO PERMIT ~ REFERENCE ONLY ~

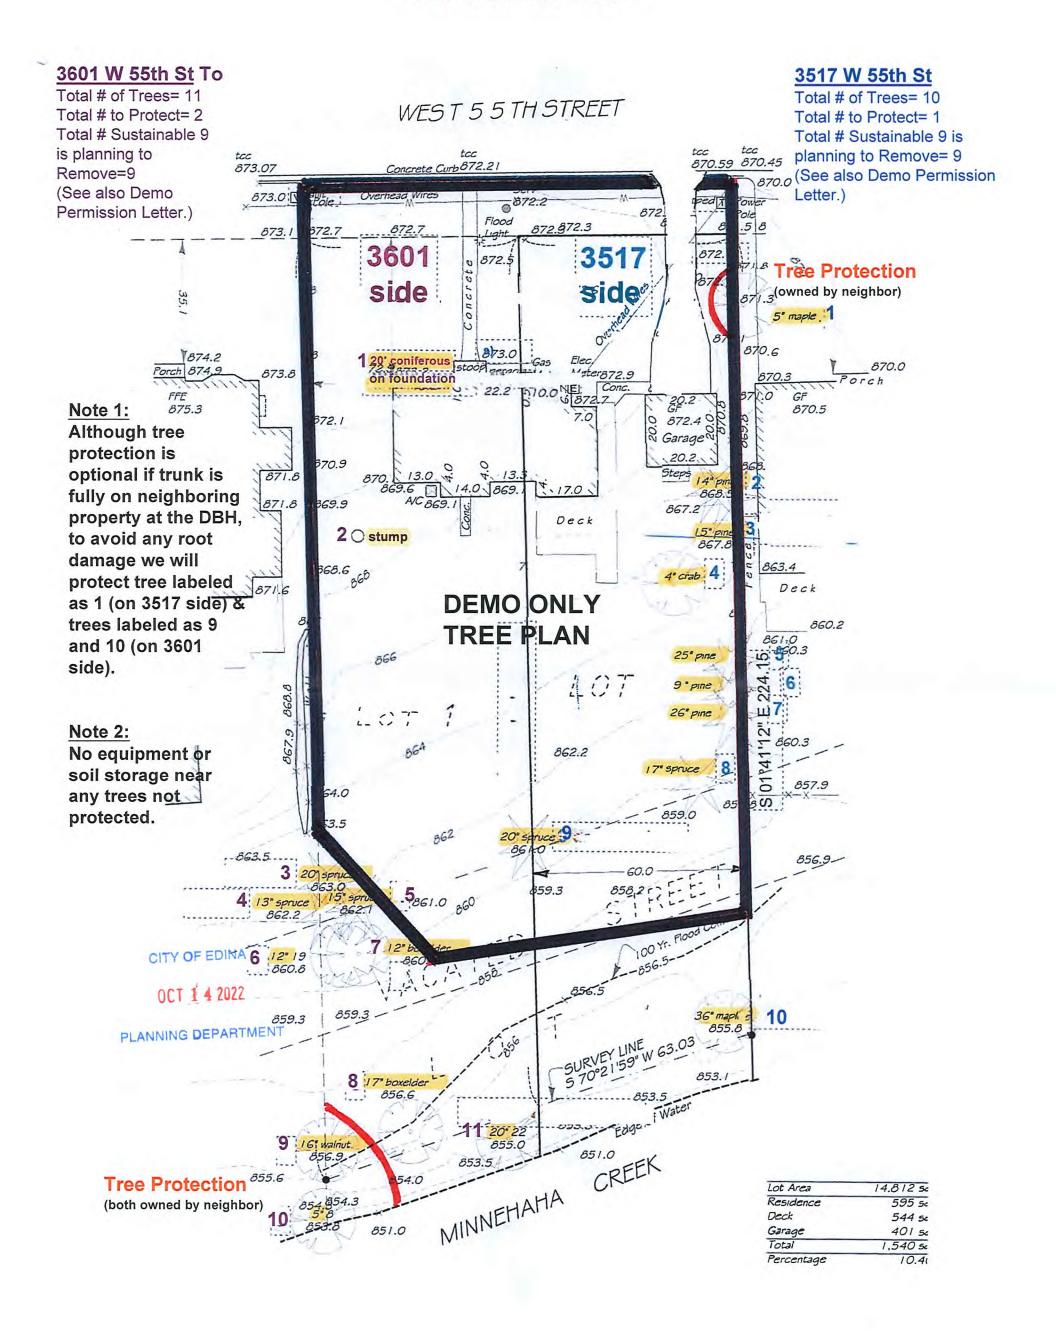



CITY OF EDINA

OCT 1 4 2022

PLANNING DEPARTMENT



CITY OF EDINA

OCT 1 4 2022

PLANNING DEPARTMENT

### \*PRE-DEMOLITION (Demo is now complete)

#### **EAST NEIGHBOR**



CITY OF EDINA

OCT 1 4 2022

PLANNING DEPARTMENT

CITY OF EDINA

OCT 1 4 2022

PLANNING DEPARTMENT

# STORMWATER MANAGEMENT PLAN

Lot 4, Block 8, Woodbury Park Near Lake Harriet

3517 West 55th Street

Edina, Minnesota

September 30<sup>th</sup>, 2022 Rev. – October 7<sup>th</sup>, 2022

Prepared By:



Prepared For:

Sustainable 9 Design & Build 3511 West 44<sup>th</sup> Street Minneapolis, Minnesota 55410

I hereby certify that this Plan, Specification or Report was prepared by me or under my direct supervision and that I am a duly Licensed Professional Engineer under the laws of the State of Minnesota.

Jeffrey A. Prasch, PE Project Engineer 52706

09.30.22

License Number

Date



#### **Table of Contents**

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#### Appendix A – Figures

Figure 1 - Drainage Areas Existing Conditions Figure 2 - Drainage Areas Proposed Conditions OCT 1 4 2022

Stormwater Management Plan 3517 West 55<sup>th</sup> Street – Edina, MN Rev. – October 7<sup>th</sup>, 2022

#### 1.0 Project Overview PLANNING DEPARTMENT

A new house with driveway is being proposed at 3517 West 55<sup>th</sup> Street in the City of Edina (City). The proposed house is located on a new lot created by a lot split of Lot 1, Block 7 Woodbury Park Near Lake Harriet (3601 W 55<sup>th</sup> Street). The lot that this project is located on is the East 60 feet of the original lot, which equates to 0.34 acres. This part of the original lot contained approximately one third of the original house along with the detached garage and driveway. There is private property located to the east and west, street to the north and Minnehaha Creek creates the south boundary for the lot. Currently, most of the site flows south directly into Minnehaha creek with part of the front yard and driveway flowing to the street and a portion of the east side yard flowing east to private property. The street and private property subcatchments flow via storm sewer into Minnehaha Creek. Minnehaha Creek is considered a regional flooding issue according to the City of Edina Engineering Department. The existing drainage conditions are shown in Figure 1.

The proposed improvements include a new house with attached garage, driveway, porch, and pool with surrounding patio. Because this lot originally only supported half of a residence, there will be a large increase in impervious surface. The stormwater from these impervious surfaces will be primarily drained to the creek via a side yard swale and grading of the new driveway. This will prohibit an increase in rates to private property. **Figure 2** shows the proposed drainage conditions.

#### 2.0 Design Considerations

The site is under the jurisdiction of Minnehaha Creek Watershed District (MCWD) and the City. This project will not trigger the MCWD stormwater rule because it is the redevelopment of a single-family home. This project will trigger Category 2 of the City's Rule because it is the redevelopment of a single-family home. The on-site storm water system design is based on their guidelines:

- Rate and Volume Modeling Software HydroCAD 10.10
- ▲ Rainfall Distribution MSE 24-hour Type III
- A Rainfall Data NOAA Atlas 14 rainfall data as shown in Figure 3.
- A Soil Conditions Hydrologic Soil Group B based on web soil survey shown in Appendix D.

#### 3.0 Subcatchment Analysis

The City regulates the rate of water discharged from the site. The discharge rate requirement is no increase in peak rate to private property for the 10-yr storm event. In regards to volume control, the site does not flow to structural flooding. It does flow into the regional flooding of Minnehaha Creek. **Table 3.1** shows the existing and proposed Subcatchment Analysis .


Table 3.1 - Subcatchment Area Summary


Subcatchment	Impervious Area [sf]		Total Area [sf]	
	Pre-	Post-	Pre-	Post-
Street (1S)	313	631	1,622	1,914
Private Property (2S)	672	0	672	471
Minnehaha Creek (3S)	1,674	5,439	12,518	12,427

As shown in the table above, the discharge rates to private property will not increase because of the decrease in impervious area and decrease in total area flowing to private property.

# **Appendix A**

**Figures** 

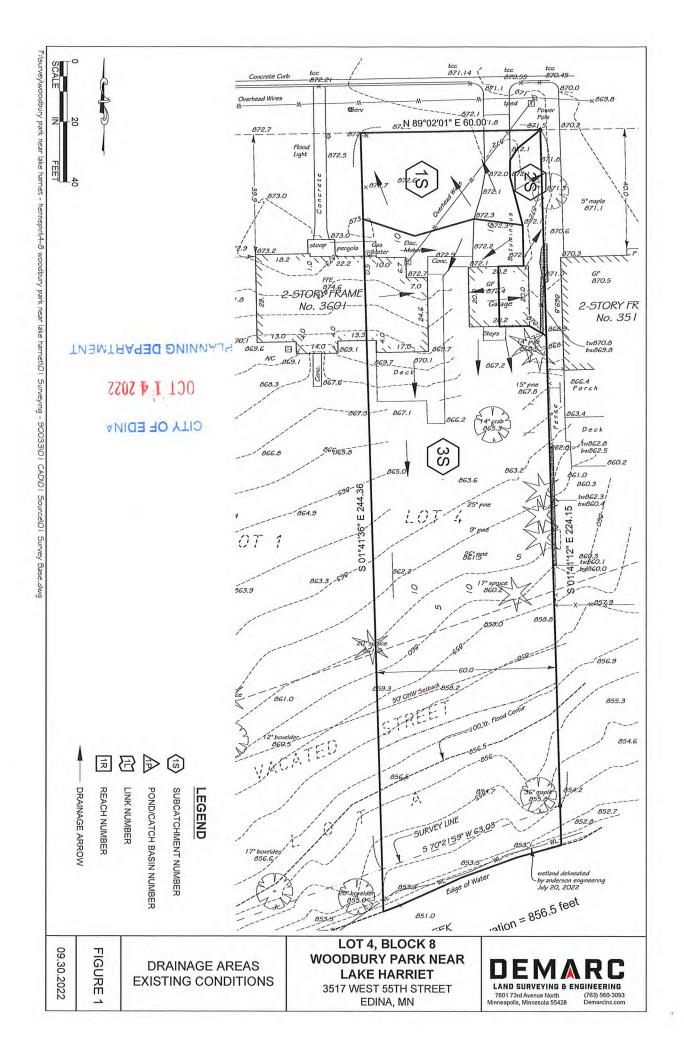

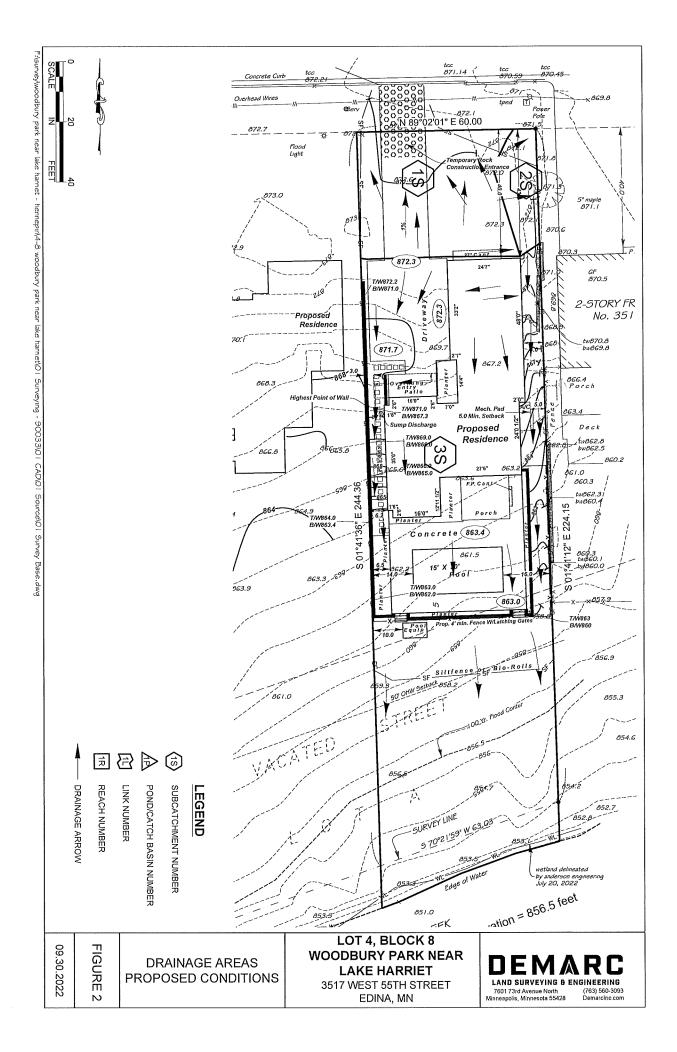

#### FIGURE 3 - PRECIPITATION DATA



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NOAA Atlas 14, Volume 8, Version 2 Location name: Minneapolis, Minnesota, USA\* Latitude: 44.9126°, Longitude: -93.3445° Elevation: 919.99 ft\*\*

\* source: ESRI Maps
\*\* source: USGS



#### CITY OF EDIN ROINT PRECIPITATION FREQUENCY ESTIMATES

Sanja Perica, Deborah Martin, Sandra Pavlovic, Ishani Roy, Michael St. Laurent, Carl Trypaluk Dale Unruh, Michael Yekta, Geoffery Bonnin

OCT 1 4 2022

NOAA, National Weather Service, Silver Spring, Maryland

#### PLANNING DEPARTMENT | PF graphical | Maps & aerials

#### PF tabular

PDS-	S-based point precipitation frequency estimates with 90% confidence intervals (in inches) <sup>1</sup>									
Duration	Average recurrence interval (years)									
10000	1	2	5	10	25	50	100	200	500	1000
5-min	<b>0.353</b> (0.288-0.438)	0.419 (0.342-0.520)	<b>0.532</b> (0.432-0.662)	<b>0.630</b> (0.509-0.788)	<b>0.773</b> (0.605-1.00)	<b>0.889</b> (0.677-1.17)	1.01 (0.741-1.35)	1.14 (0.798-1.56)	1.31 (0.884-1.85)	1.45 (0.949-2.07
10-min	0.517 (0.422-0.642)	0.613 (0.501-0.762)	<b>0.778</b> (0.633-0.970)	<b>0.923</b> (0.746-1.15)	1.13 (0.886-1.47)	1.30 (0.992-1.71)	1.48 (1.09-1.98)	1.67 (1.17-2.29)	1.92 (1.30-2.71)	2.13 (1.39-3.03
15-min	0.630 (0.515-0.783)	<b>0.748</b> (0.610-0.929)	0.949 (0.772-1.18)	1.13 (0.909-1.41)	1.38 (1.08-1.79)	1.59 (1.21-2.08)	1.80 (1.32-2.42)	2.03 (1.43-2.79)	2.35 (1.58-3.31)	2.60 (1.70-3.69
30-min	0.891 (0.729-1.11)	1.07 (0.870-1.32)	1.36 (1.11-1.70)	1.62 (1.31-2.03)	2.00 (1.56-2.59)	2.30 (1.75-3.01)	<b>2.61</b> (1.92-3.50)	2.94 (2.07-4.05)	3.40 (2.29-4.79)	3.77 (2.46-5.36
60-min	1.16 (0.950-1.44)	1.39 (1.13-1.72)	1.78 (1.45-2.22)	2.15 (1.74-2.69)	2.70 (2.13-3.54)	3.17 (2.42-4.19)	3.67 (2.70-4.95)	<b>4.21</b> (2.96-5.82)	<b>4.99</b> (3.36-7.05)	<b>5.61</b> (3.66-7.98
2-hr	1.43 (1.18-1.77)	1.70 (1.40-2.10)	2.21 (1.81-2.73)	2.68 (2.18-3.33)	3.41 (2.71-4.46)	4.04 (3.12-5.32)	<b>4.73</b> (3.51-6.36)	<b>5.48</b> (3.89-7.54)	<b>6.57</b> (4.47-9.25)	<b>7.46</b> (4.90-10.5
3-hr	1.60 (1.32-1.96)	1.89 (1.56-2.33)	2.46 (2.02-3.03)	3.00 (2.45-3.71)	3.87 (3.10-5.07)	<b>4.63</b> (3.60-6.10)	<b>5.48</b> (4.09-7.36)	<b>6.41</b> (4.58-8.82)	7.78 (5.33-10.9)	<b>8.91</b> (5.89-12.5
6-hr	1.88 (1.56-2.29)	2.21 (1.83-2.70)	2.86 (2.36-3.50)	3.51 (2.88-4.31)	<b>4.56</b> (3.69-5.96)	<b>5.49</b> (4.30-7.20)	<b>6.53</b> (4.92-8.74)	<b>7.69</b> (5.54-10.5)	9.41 (6.49-13.2)	10.8 (7.21-15.1
12-hr	2.13 (1.78-2.58)	2.53 (2.11-3.06)	3.27 (2.72-3.97)	3.98 (3.29-4.86)	5,09 (4.12-6.56)	6.06 (4.76-7.85)	<b>7.11</b> (5.38-9.41)	8.28 (5.99-11.2)	9.97 (6.92-13.8)	11.4 (7.62-15.8)
24-hr	2.49 (2.09-3.00)	2.86 (2.40-3.45)	3.58 (2.99-4.32)	4,29 (3.56-5.19)	<b>5.41</b> (4.41-6.92)	6.39 (5.06-8.23)	7.49 (5.71-9.85)	8.71 (6.35-11.7)	10.5 (7.34-14.4)	12.0 (8.09-16.5
2-day	2.90 (2.45-3.46)	3.25 (2.74-3.88)	3.94 (3.31-4.72)	<b>4.63</b> (3.87-5.57)	5.76 (4.74-7.32)	6.76 (5.39-8.64)	<b>7.88</b> (6.05-10.3)	9.13 (6.72-12.2)	<b>11.0</b> (7.75-15.0)	12.5 (8.53-17.1
3-day	3.17 (2.68-3.76)	3.52 (2.98-4.19)	<b>4.23</b> (3.56-5.04)	<b>4.93</b> (4.13-5.90)	6.06 (5.00-7.66)	<b>7.07</b> (5.66-9.00)	8.20 (6.33-10.7)	9.47 (7.00-12.6)	11.3 (8.03-15.4)	12.9 (8.82-17.5
4-day	3.37 (2.87-4.00)	3.76 (3.19-4.46)	<b>4.50</b> (3.80-5.35)	<b>5.22</b> (4.39-6.23)	6.38 (5.27-8.01)	7.40 (5.93-9.36)	8.52 (6.59-11.0)	9.78 (7.24-12.9)	11.6 (8.25-15.7)	13.1 (9.02-17.8)
7-day	3.88 (3.31-4.57)	<b>4.38</b> (3.74-5.16)	<b>5.27</b> (4.48-6.23)	6.09 (5.14-7.22)	<b>7.31</b> (6.02-9.04)	8.34 (6.69-10.4)	9.44 (7.31-12.1)	10.6 (7.89-13.9)	12.3 (8.78-16.5)	13.7 (9.46-18.5
10-day	<b>4.37</b> (3.74-5,13)	<b>4.95</b> (4.24-5.82)	<b>5.96</b> (5,08-7.01)	6.83 (5.79-8.08)	8.11 (6.67-9.93)	9.15 (7.34-11.3)	<b>10.2</b> (7.93-13.0)	11.4 (8.45-14.8)	13.0 (9.26-17.3)	<b>14.2</b> (9.87-19.1
20-day	<b>5.94</b> (5.12-6.92)	6.67 (5.74-7.77)	<b>7.86</b> (6.74-9.19)	8.86 (7.56-10.4)	10.3 (8.45-12.4)	<b>11.3</b> (9.13-13.8)	<b>12.4</b> (9.67-15.5)	13.5 (10.1-17.3)	15.0 (10.8-19.7)	<b>16.1</b> (11.3-21.6
30-day	7.33 (6.34-8.50)	8.19 (7.07-9.50)	9.56 (8.23-11.1)	10.7 (9.14-12.5)	<b>12.2</b> (10.1-14.6)	13.3 (10.8-16.2)	14.5 (11.3-17.9)	15.6 (11.7-19.8)	17.0 (12.3-22.2)	18.1 (12.7-24.1)
45-day	9.13 (7.93-10.5)	10.2 (8.84-11.8)	11.9 (10.2-13.7)	<b>13.2</b> (11.3-15.3)	14.9 (12.3-17.7)	16.2 (13.1-19.5)	17.4 (13.6-21.4)	18.5 (13.9-23.4)	19.9 (14.4-25.8)	20.9 (14.8-27.7)
60-day	10.7 (9.30-12.3)	<b>12.0</b> (10.4-13.8)	13.9 (12.1-16.1)	15.5 (13.3-17.9)	17.4 (14.4-20.5)	18.8 (15.2-22.5)	<b>20.1</b> (15.7-24.6)	21.2 (16.0-26.7)	22.6 (16.4-29.2)	23.5 (16.7-31.1)

Precipitation frequency (PF) estimates in this table are based on frequency analysis of partial duration series (PDS).

Numbers in parenthesis are PF estimates at lower and upper bounds of the 90% confidence interval. The probability that precipitation frequency estimates (for a given duration and average recurrence interval) will be greater than the upper bound (or less than the lower bound) is 5%. Estimates at upper bounds are not checked against probable maximum precipitation (PMP) estimates and may be higher than currently valid PMP values.

Please refer to NOAA Atlas 14 document for more information.

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**DATE:** 10/28/2022

**TO:** Cary Teague – Planning Director

FROM: Zuleyka Marquez, PE – Graduate Engineer RE: 3517 55<sup>th</sup> St W - Subdivision Review

The Engineering Department has reviewed the subject property for street and utility concerns, grading, stormwater, erosion and sediment control and for general adherence to the relevant ordinance sections.

This review was performed at the request of the Planning Department; a more detailed review will be performed at the time of building permit application. Plans reviewed included a stormwater management plan and report, existing and proposed surveys.

#### Summary of Work

The applicant proposes a lot split to build two homes. The existing home has already been demolished.

#### Survey & Easements

The benchmark is based on a hydrant in a recent reconstruction area. The benchmark may not be accurate.

A 24" sanitary sewer main is located in the rear yard. Surveyor must show on survey. A 20'-wide easement centered on the pipe shall be provided. Recorded easement required for permit closeout.

#### Grading and Drainage

The site drains to the street and Minnehaha Creek in both the existing and proposed condition. The existing conditions sheet drained slightly SE towards private property. Swales are proposed along the narrow east property line to drain south directly towards the creek.

#### Stormwater Mitigation

Stormwater was reviewed and is consistent with City of Edina Building Policy SP-003 standards. A final grade as-built survey and inspection will be required to verify compliance with the approved stormwater plan.

#### Floodplain Development

The FEMA 1% annual chance floodplain is located in the rear yard, with a base flood elevation of 855.9'. Thus, the lowest floor elevation is required at no less than 857.9'. The golf simulator slab is proposed at 860.2'.

#### Erosion and Sediment Control

An erosion and sediment control plan was reviewed and is consistent with City of Edina Building Policy SP-002. Suggest a double row of silt fence in the rear yard due to the steep slope.

#### Street and Driveway Entrance

The applicant proposes to relocate the driveway entrance. Existing driveway entrance to be closed up per standard plate 500. A driveway entrance permit will be required. The street was reconstructed in 2021. Refer to standard plates 540 and 541 for patching requirements.



#### Public Utilities

Water and sanitary is served from 55<sup>th</sup> St W. Sanitary is also available from the rear yard. A one-inch water service line from the curb stop to the dwelling is required per the City's policy SP-024. Sewer and water connection fees shall be paid prior to building permit issuance.

#### Miscellaneous

A Minnehaha Creek Watershed District permit may be required, applicant will need to verify with the district.

Retaining walls no more than 4' are proposed. Engineering is not required.


#### 3517 W 55th St, Edina, MN 55410 - PID 2002824220119

#### **VARIANCE APPLICATION:**

SUMMARY: A double wide lot of 120ft wide with one single family home was split into two new legal parcels each at 60ft wide by the previous homeowner and purchased as such by Sustainable 9 Design Build. Sustainable 9 Design Build has since sold one of the new lots (3517 W 55th St, Edina, MN 55410 with PID 2002824220119) to our clients who intend to build a new single family home, Andrew and Brandy Morris. The remaining lot (3601 W 55th St, Edina, MN 55410 with PID 2002824220118) is still owned by S9 and a new single family spec home has been designed. A demolition permit was already pulled and the old existing home has been removed.

ISSUE: The standard allowable width for new Edina lots is 75ft. Both of these new lots are only 60ft wide. Thus, we have been informed only recently that the lot split (which Sustainable 9 had been told was complete at the time of the original land purchase) will not be deemed official and complete until a variance is filed and approved.

PROPOSAL: We believe this variance should be approved primarily because it corrects an extraordinary circumstance and the result is more in keeping with the essential character of the neighborhood then what was there previously. All of the adjacent neighbors and vast majority of the surrounding neighborhood is set at 60ft or less for their lot width. At our neighborhood meeting for the demolition, the neighbor to the east of the two lots in question noted his support of this variance, Eric Michael at 3511 55th St W, Edina, MN 55410 with PtD 2002824220108. We all believe this variance would create a cohesive street of nice homes on 60ft wide lots.

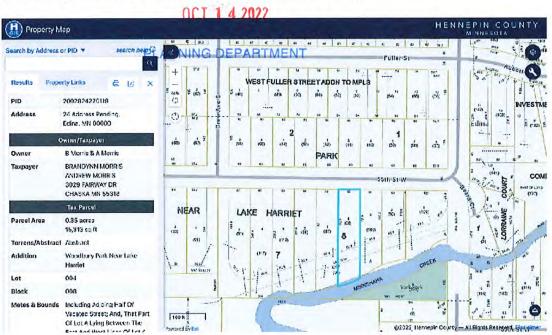





# MORRIS RESIDENCE

for ANDREW & BRANDY MORRIS 3517 WEST 55TH ST EDINA, MN 55410 1 4 2022

C1 1

C

VARIANCE SUBMITTAL


=>

UNFOLD ARCHITECTURE

**ORRIS RESIDENCE** 

SHEET NAME
COVER SHEET

A O O

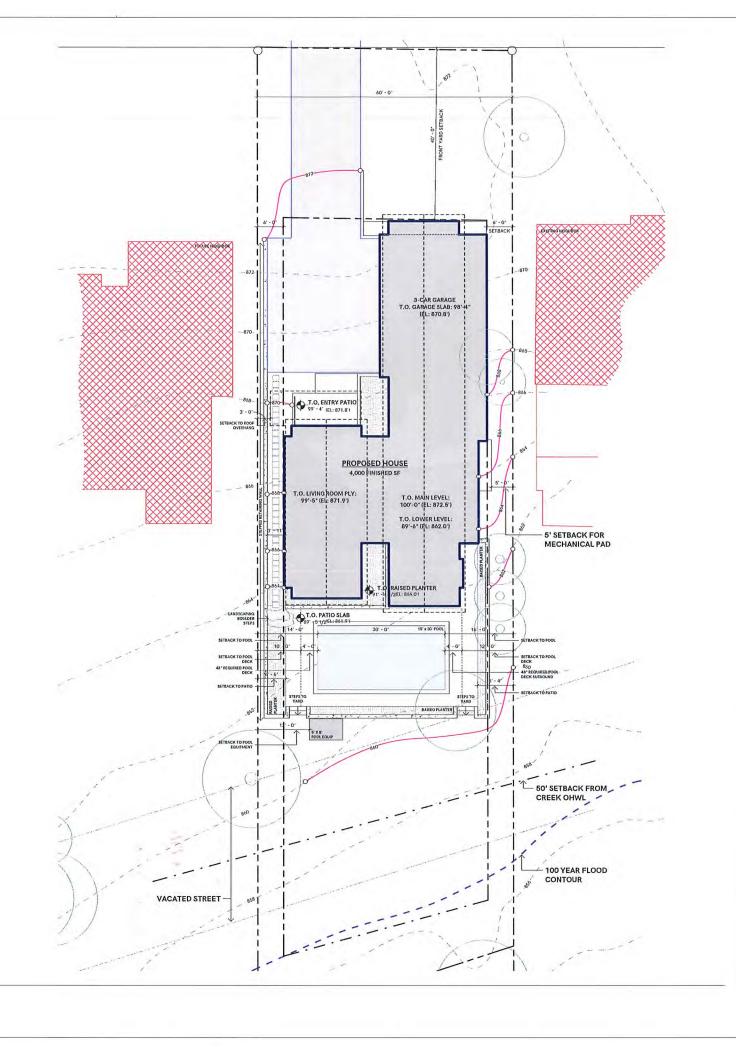

#### SITE PLAN LEGEND



PROPOSED ACCESSORY STRUCTURE

763,486,7779 www.unfoldarchitecture.com

SPACE RESERVED FOR AHD STAM

UNFULD ARCHITECTURE

CONSULTING





CIVIL ENGINEER & SURVEYOR:

DEMARC LAND SURVEYING & ENG. 7501 73RD AVE NI. WWW.DEMARCING.COM

# MORRIS RESIDENCE 3517 WEST 55TH ST EDINA, MN 55410

PROJECT NUMBER 2207 SHEET NAME ARCHITECTURAL SITE PLAN

.....

KXX . . . . .

**ZONING INFORMATION** 

LANDSCAPED AREA

SILT FENCING

TOTAL LOT AREA: 14,812 SF

**BUILDING COVERAGE:** ALLOWABLE (25%):

3,703.50 SF ACTUAL: (23.18%): 3,434.00 SF

HARDCOVER: ALLOWABLE (50%): ACTUAL (40.98%)

7,406.00 SF 6,070.00 SF - BUILDING FOOTPRINT: 2,583.00 SF - ADDITIONAL HARDSCAPE: 3,487.00 SF

MAX BUILDING HEIGHT:

ALLOWABLE: ACTUAL: AVG. EXTG GRADE:

**LOWER LEVEL CALCULATION** 

TOTAL LINEAR FEET OF WALL:

203 LF

2,162.0 SF

(56%)

30.0 29.5

870'

Measuring from Top of Lower Level Slab to Top of Main Level Ply

- 40' Linear Feet @ 11' 8 3/4" (11.73') = 469.2 SF - 33' Linear Feet @ 9'-11" (9.92') = 327.4 SF - 130' Linear Feet @ 10'-6" (10.5') = 1,365.0 SF

TOTAL SURFACE AREA OF WALL:

SURFACE AREA BELOW GRADE: 1,210.2 SF

SURFACE AREA ABOVE GRADE:


951.8 SF (44%)



NOTE: ARCHITECTURAL SITE PLAN IS SCHEMATIC ONLY. REVIEW RESIDENCE LOCATION, SITE SETBACKS, GRADING, AND APPLICABLE LOCAL CODES WITH A LICENSED CIVIL ENGINEER.

ARCHITECTURAL SITE PLAN

1° = 10'-0"

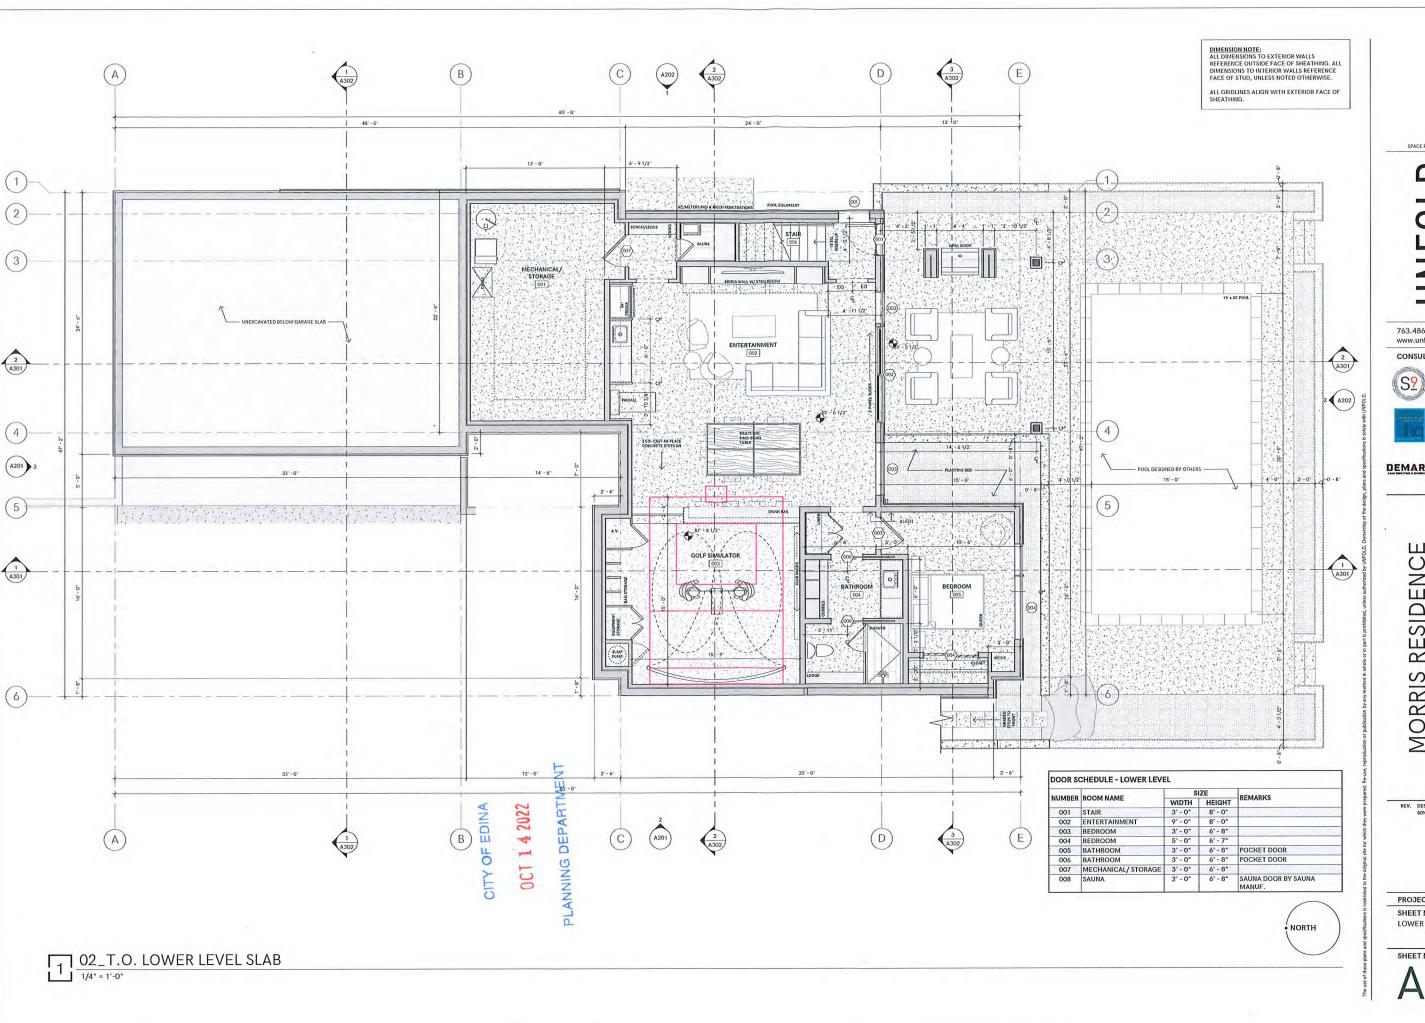

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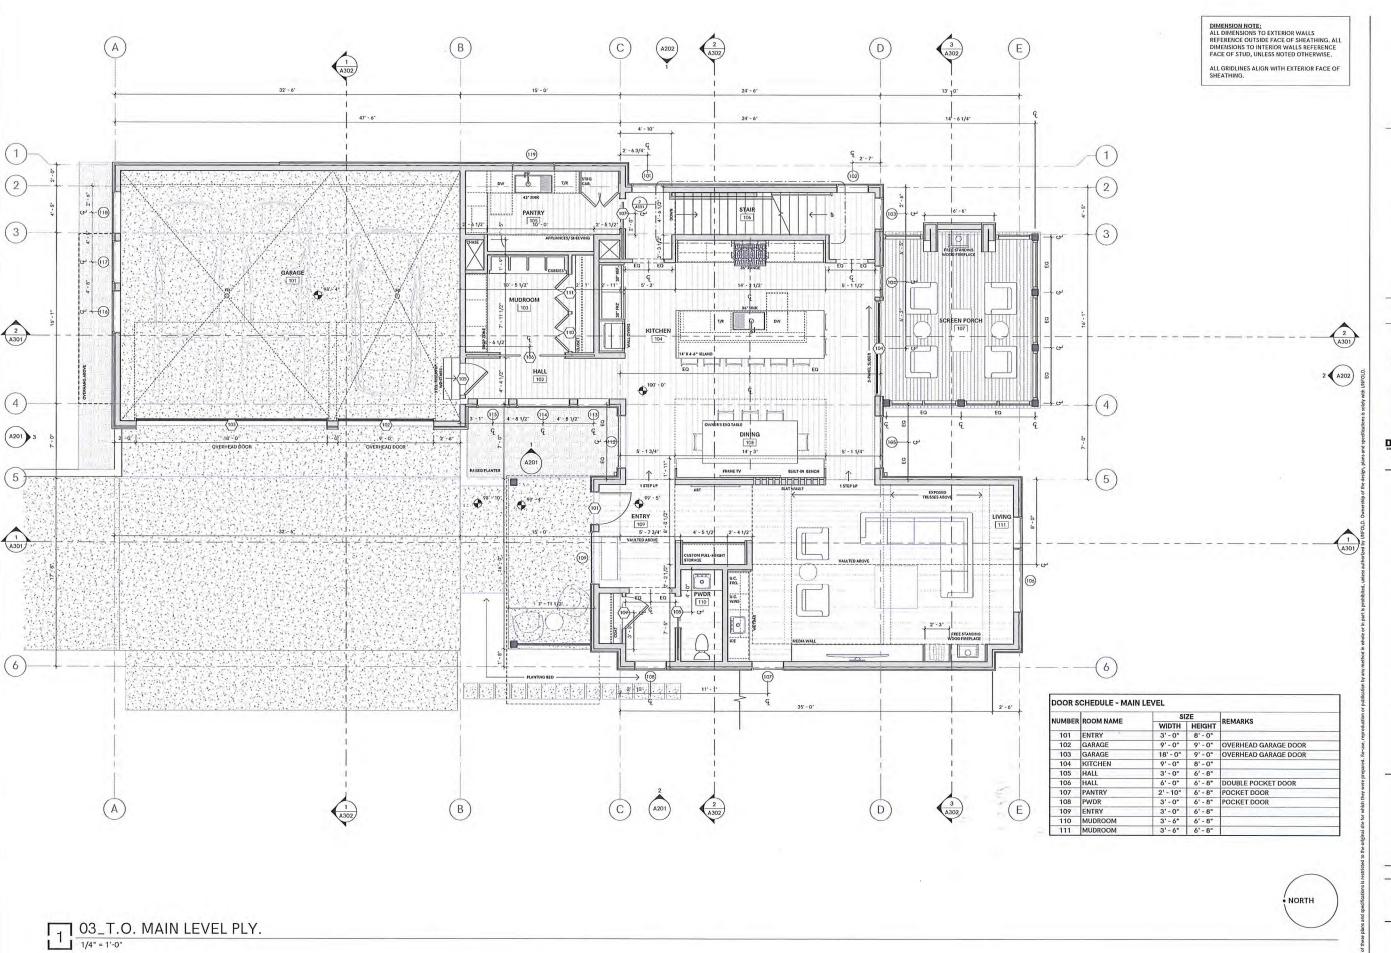
DEMARC LAND SURVEYING & ENG. 7601 73RD AVE N. MINNEAPOLIS, MN 55428 WWW.DEMARCING.COM

MORRIS RESIDENCE 3517 WEST 55TH ST EDINA, MN 55410

REV. DESCRIPTION 50% CD's DATE 09/21/2022

PROJECT NUMBER 2207

SHEET NAME LOWER LEVEL FLOOR PLAN



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STRUCTURAL ENGINEER:
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3407 KILMER LANE NORTH
PLYMOUTH, MN 55446

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7601 73RD AVE N.
MINNEAPOLIS, MN 55428
WWW.DEMARCING.COM

MORRIS RESIDENCE 3517 WEST 55TH ST EDINA, MN 55410

REV. DESCRIPTION DATE 50% CD's 09/21/2022


PROJECT NUMBER
SHEET NAME

2207

MAIN LEVEL FLOOR PLAN

SHEET NUMBER

A102

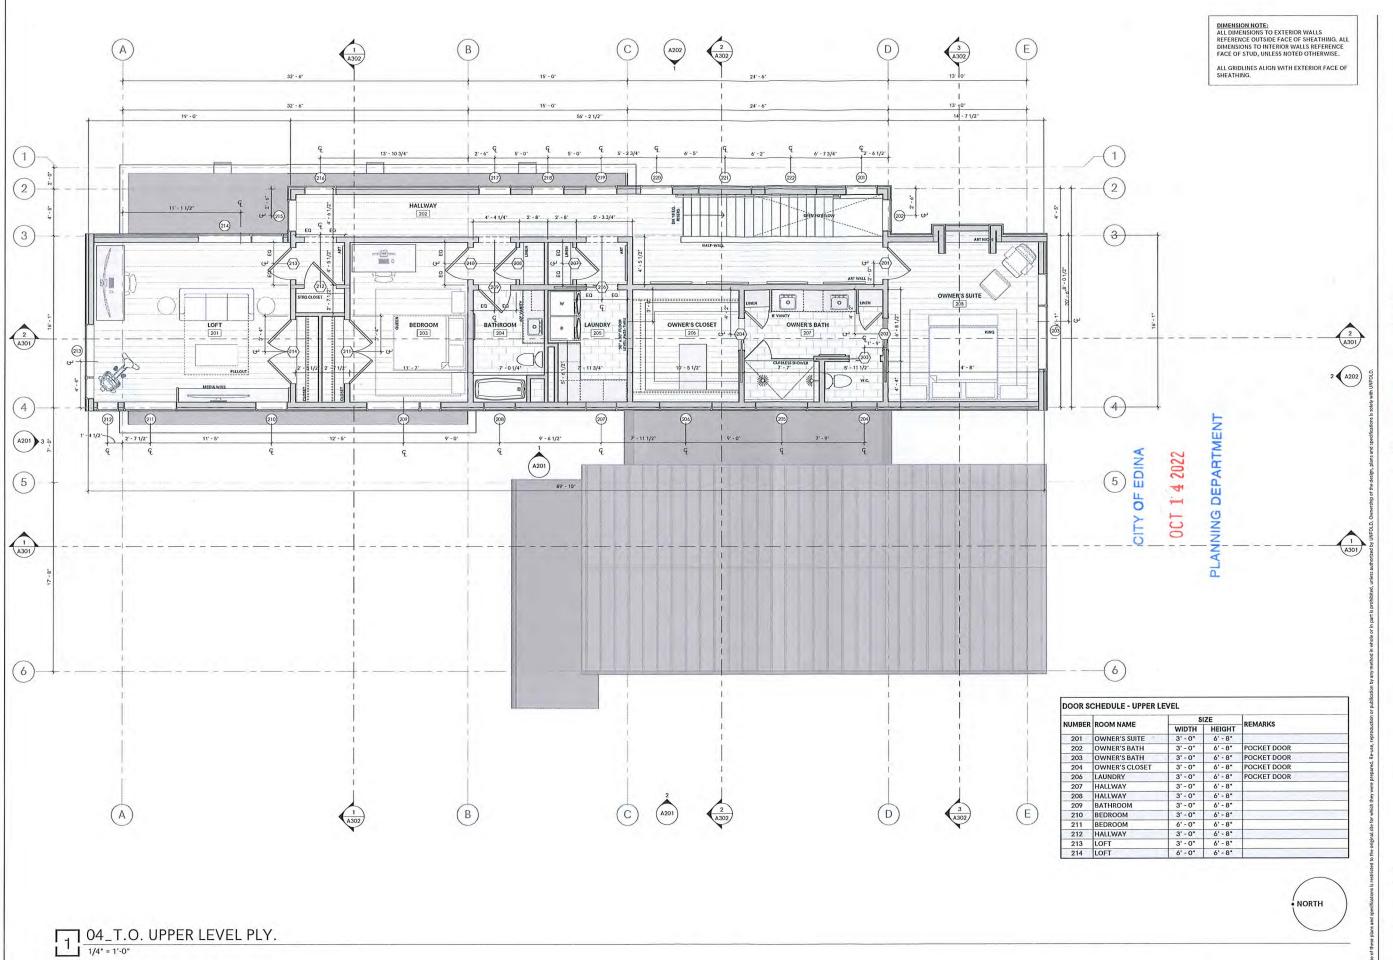

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STRUCTURAL ENGINEER:

THE HANSON GROUP 3407 KILMER LANE NORTH PLYMOUTH, MN 55446 WWW. HANSONGROUPMN C

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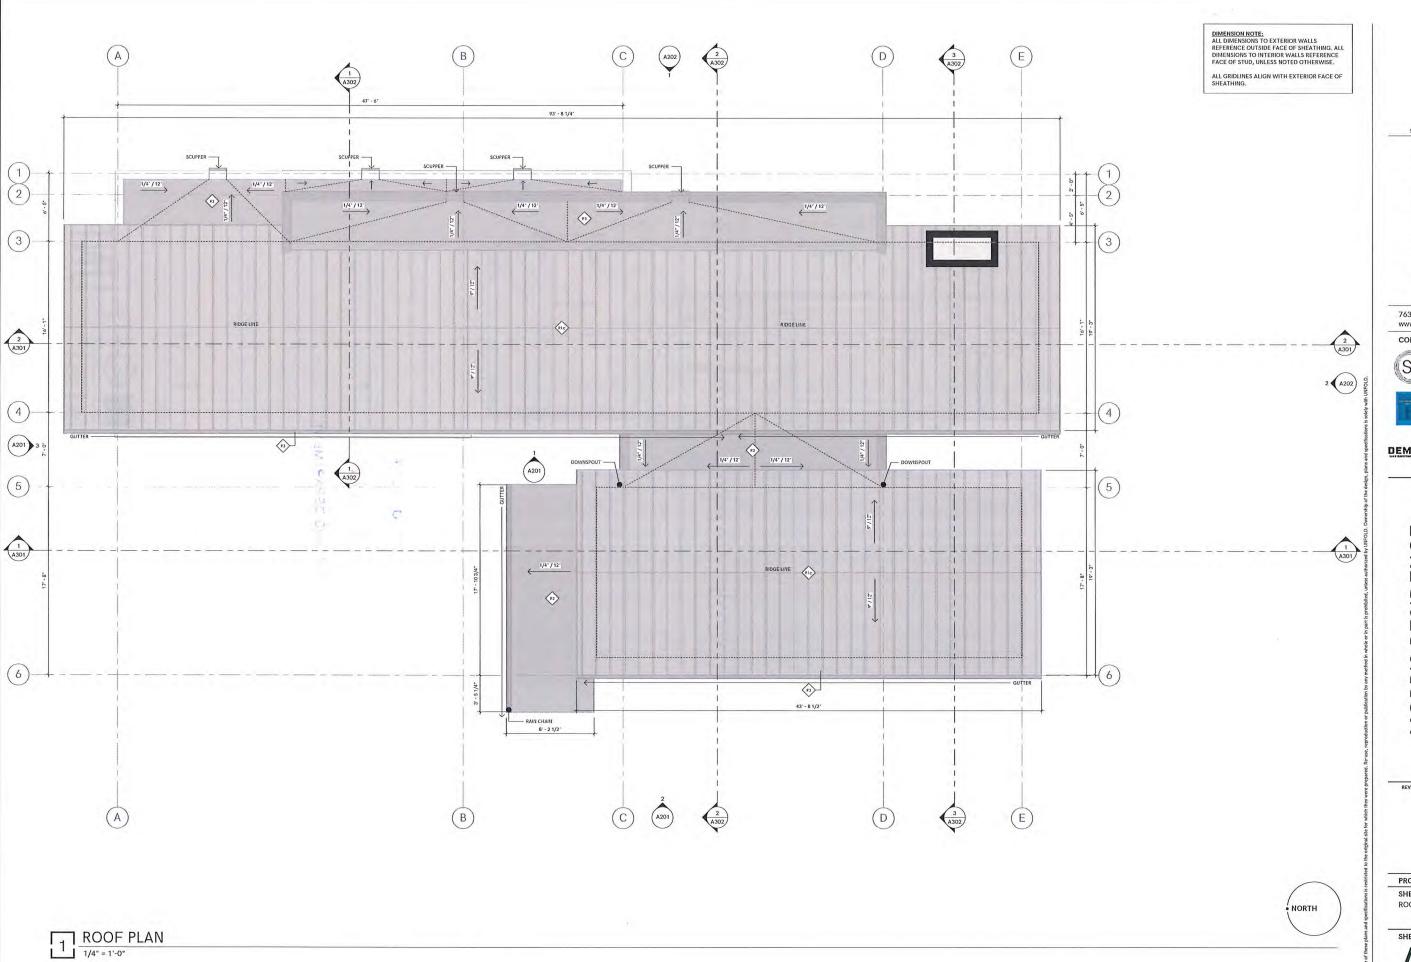
MORRIS RESIDENCE 3517 WEST 55TH ST EDINA, MN 55410

REV. DESCRIPTION 50% CD's DATE 09/21/2022

PROJECT NUMBER

2207

SHEET NAME UPPER LEVEL FLOOR PLAN



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MORRIS RESIDENCE 3517 WEST 55TH ST EDINA, MN 55410

PROJECT NUMBER 2207

SHEET NAME ROOF LEVEL PLAN





EXTERIOR ELEVATION - EAST

3/16" = 1'-0"

MATERIAL KEYNOTE LEGEND KEYVALUE MATERIAL DESCRIPTION LIGHT STUCCO HARDIE PANELING (DARK FINISH) WOOD LOOK SIDING STONE VENEER (LIGHT FINISH) STANDING SEAM METAL ROOFING (DARK FINISH) SCREEN PORCH CONCRETE RETAINING WALL TIMBER POST & BEAM CONSTRUCTION DARK PREFINISHED METAL DOWNSPOUT/GUTTER DARK PREFINISHED MINIMAL METAL SCUPPER. TYPICAL PREFINISHED METAL COPING (DARK FINISH) 2x6 HARDIE FASCIA BOARD (DARK FINSIH) POWDER COATED CHIMNEY SHROUD (DARK FINISH) CAST-IN-PLACE CONCRETE PORCH WOOD SLAT SCREEN WALL PREFINISHED METAL OVERHEAD GARAGE DOORS (DARK FINISH) STEPPED CONCRETE PAVERS ADDRESS SIGNAGE ON WOOD PANELING

SPACE RESERVED FOR AHJ STAMP

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THE HANSON GROUP 3407 KILMER LANE NORTH PLYMOUTH, MN 55446

CIVIL ENGINEER & SURVEYOR DEMARC LAID SURVEYING & ENG. 7601 738D AVE N. MINISAPOLIS, MMI 5542B WWW,DEMARCING.COM

MORRIS RESIDENCE 3517 WEST 55TH ST EDINA, MN 55410

REV. DESCRIPTION

DATE 09/21/2022

PROJECT NUMBER 2207

SHEET NAME EXTERIOR ELEVATIONS



3517 WEST 55TH STREET

3601 WEST 55TH STREET

PLANNING DEPARTMENT

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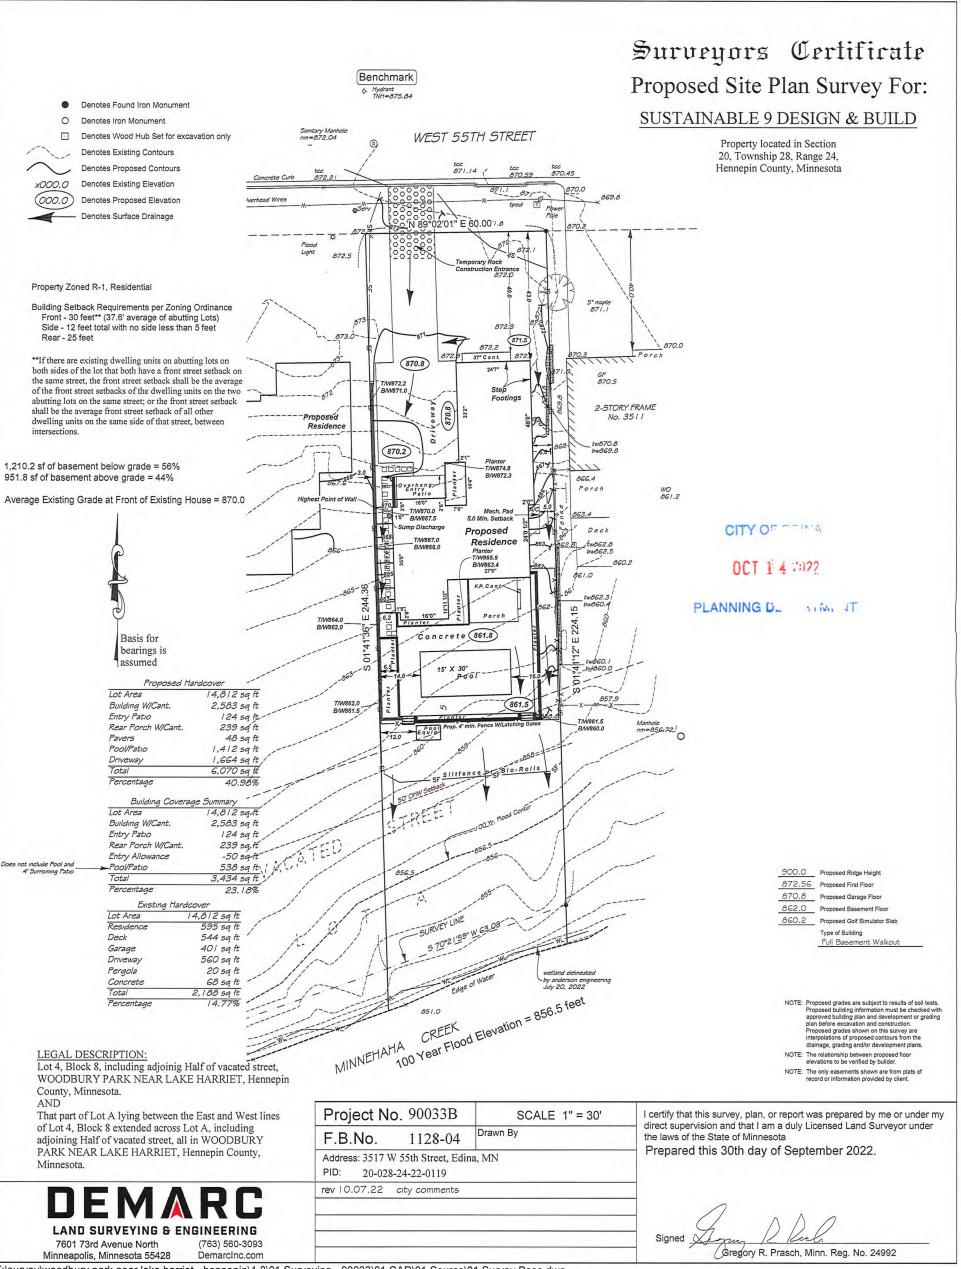
MORRIS RESIDENCE 3517 WEST 55TH ST EDINA, MN 55410


PROJECT NUMBER 2207

SHEET NAME RENDERING

#### Surveyors Certificate Existing Conditions Survey For: SUSTAINABLE 9 DESIGN & BUILD Property Zoned R-1, Residential Building Setback Requirements per Zoning Ordinance Property located in Section Front - 30 feet\*\* (37.6' average of abutting Lots) Side - 12 feet total with no side less than 5 feet 20, Township 28, Range 24, Hennepin County, Minnesota Rear - 25 feet Basis for 3517 W 55th St bearings is \*\*If there are existing dwelling units on abutting lots on both assumed sides of the lot that both have a front street setback on the Benchmark same street, the front street setback shall be the average of the Denotes Found Iron Monument front street setbacks of the dwelling units on the two abutting lots on the same street; or the front street setback shall be the Denotes Iron Monument average front street setback of all other dwelling units on the **Denotes Existing Contours** same side of that street, between intersections. WEST 55TH STREET ® PIM=872.04 Denotes Existing Elevation tcc tcc 870.59 870.45 tcc 872.84 873.0 V -N 89°02'01" E 60,00 872.5 872.7872.6 872.9 39.5 873.0 873.2 872.3873.2 873.8 orch 875.3 2-STORY FRAME 2-STORY FRAME No. 3601 No. 3511 2-STORY FRAME 870.9 No. 3605 869.7 870. 869.9 Deck WO 861.2 Deck 36 865.0 861.0 244. 870 8 Ш 26" pine 861.5 860.3 863.3 Manhole rım=856.72 856.9-CITY OF EDINA 855.3 OCT 1 4 2022 100 Yr. 854.6 PLANNING DEPART 853.0 859.3 wetland delineated by anderson engineering July 20, 2022 100 Year Flood Elevation = 856.5 feet 855.6 Lot Area 14,812 sq ft 595 sq ft Residence Deck 544 sq ft Garage 401 sq ft 851.0 1,540 sq ft Total LEGAL DESCRIPTION: Percentage Lot 4, Block 8, including adjoinig Half of vacated street, WOODBURY PARK NEAR LAKE HARRIET, Hennepin The only easements shown are from plats of record or County, Minnesota. information provided by client. AND That part of Lot A lying between the East and West lines Project No. 90033 I certify that this survey, plan, or report was prepared by me or under my SCALE 1" = 30' of Lot 4, Block 8 extended across Lot A, including direct supervision and that I am a duly Licensed Land Surveyor under adjoining Half of vacated street, all in WOODBURY 1128-04 the laws of the State of Minnesota F.B.No. PARK NEAR LAKE HARRIET, Hennepin County, Surveyed this 6th day of July 2022. Address Pending, Edina, MN Address: Minnesota. PID No.: 20-028-24-22-0119 rev 08.8.22 wetland delineation 7601 73rd Avenue North


Gregor R. Prasch, Minn. Reg. No. 24992



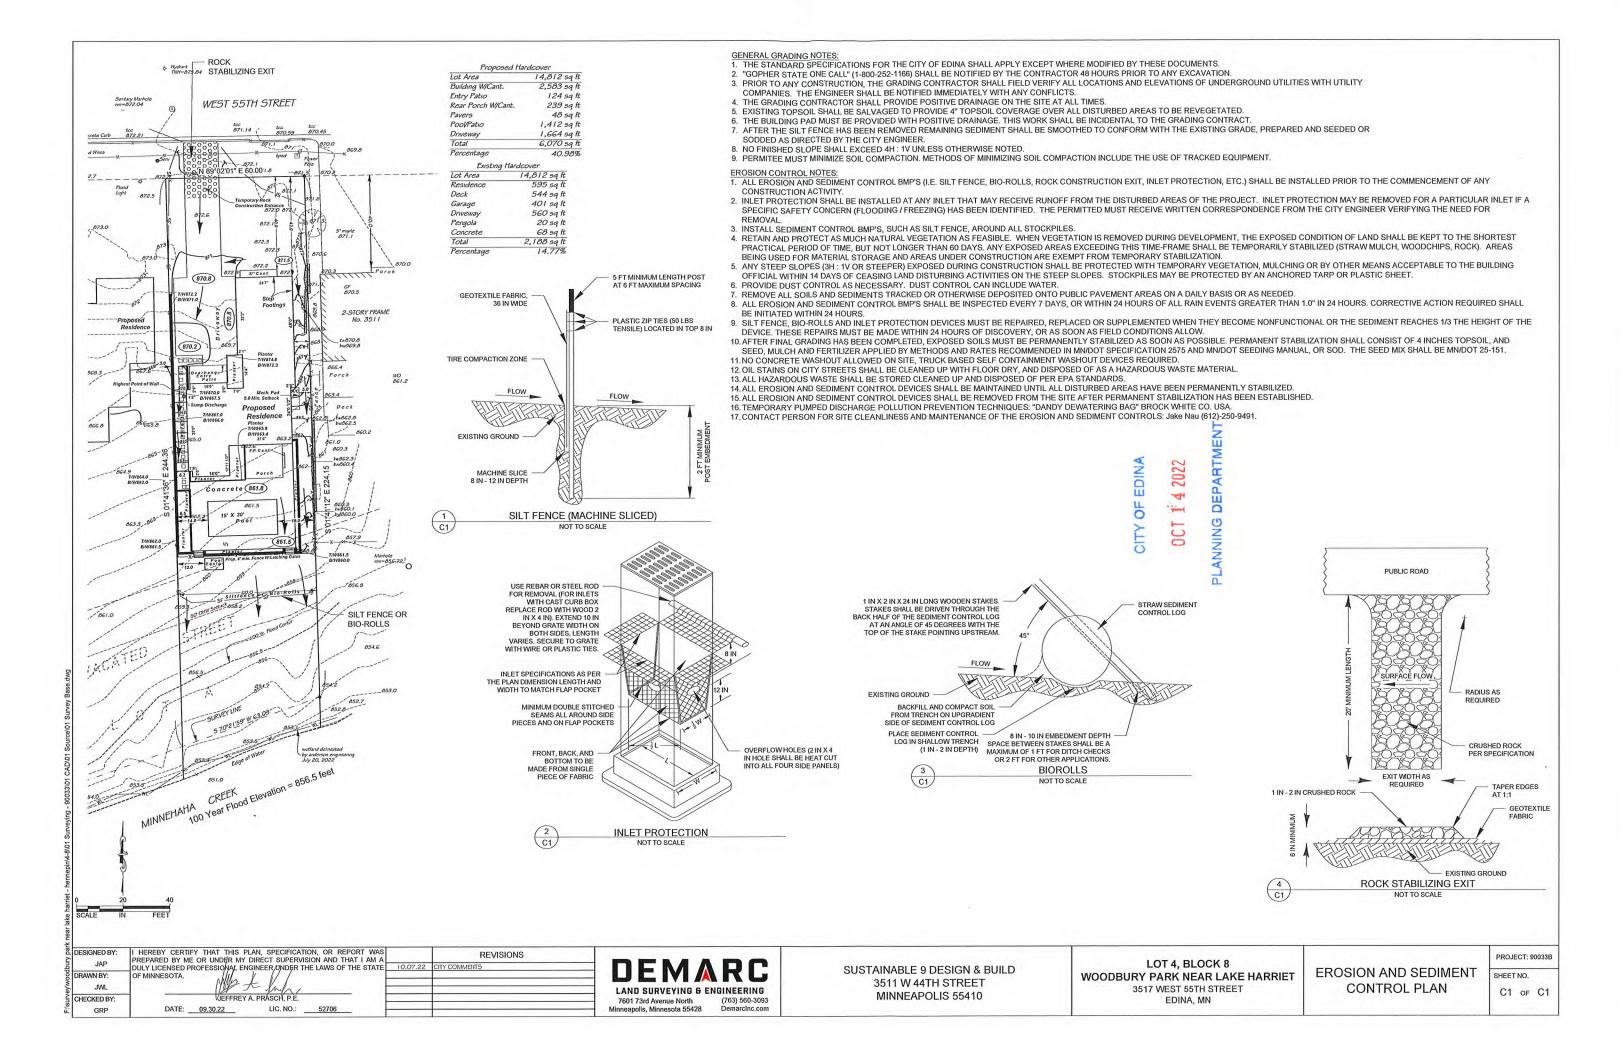

Tree Removals Tree # To be Removed To Be Preserved To Be Replaced Surveyors Certificate 3 36" Silver Maple 8 20" Spruce 9 17" Spruce Tree Preservation Plan For: 026" Pine ① 9" Pine ② 25" Pine ③ 15" Pine SUSTAINABLE 9 DESIGN & BUILD (14) 14" Pine (15) 14" Crab Property located in Section 20, Township 28, Range 24, Hennepin County, Minnesota Basis for bearings is assumed Benchmark Denotes Found Iron Monument Denotes Iron Monument Sanitary Manhole **Denotes Existing Contours** rim = 872.04Denotes Existing Elevation tcc tcc 870.59 870.45 tcc 872.84 Denotes Tree To Be Removed tcc 873.07 873.0 Valle 02'01" E 60.0071.8 Light 872.5 872.9 872. 873.0 873.2 872.3 873.0 870.0 870.5 No. 360 2-STORY FRAME No. 3605 AC 869. Proposed Residence WO 867.1 85665.8 365.0 \$66.2 863.5 CITY OF EDINA NON-REPLACEMENT TREE SETBACK LINE (T 855.3 OCT 1 4 2022 854.6 PLANNING DEPARTMEN 860.8 859.3 Manhole rim=857.81 Property Zoned R-1, Residential 100 Year Flood Elevation = 856.5 feet Building Setback Requirements per Zoning Ordinance Front - 30 feet\*\* (37.6' average of abutting Lots) Side - 12 feet total with no side less than 5 feet Rear - 25 feet \*\*If there are existing dwelling units on abutting lots on both sides of the lot that both have a front street setback on the same street, the front street setback shall be the average 851.0 of the front street setbacks of the dwelling units on the two LEGAL DESCRIPTION: abutting lots on the same street; or the front street setback Lot 4, Block 8, including adjoinig Half of vacated street, shall be the average front street setback of all other WOODBURY PARK NEAR LAKE HARRIET, Hennepin dwelling units on the same side of that street, between County, Minnesota. The only easements shown are from plats of record or intersections. AND information provided by client. That part of Lot A lying between the East and West lines Project No. 90033A I certify that this survey, plan, or report was prepared by me or under my SCALE 1" = 30' of Lot 4, Block 8 extended across Lot A, including direct supervision and that I am a duly Licensed Land Surveyor under adjoining Half of vacated street, all in WOODBURY Drawn By F.B.No. the laws of the State of Minnesota 1128-04 PARK NEAR LAKE HARRIET, Hennepin County, Surveyed this 6th day of July 2022. Address: 3517 West 55th Street, Edina, MN Minnesota. 20-028-24-22-0119 rev 10.13.22 tree removals 7601 73rd Avenue North (763) 560-3093 Gregory R. Prasch, Minn. Reg. No. 24992 Minneapolis, Minnesota 55428 DemarcInc.com F:\survey\woodbury park near lake harriet - hennepin\4-8\01 Surveying - 90033\01 CAD\01 Source\01 Survey Base.dwg

# \*TREE PLAN SUBMITTED AND APPROVED FOR DEMO PERMIT ~ REFERENCE ONLY ~

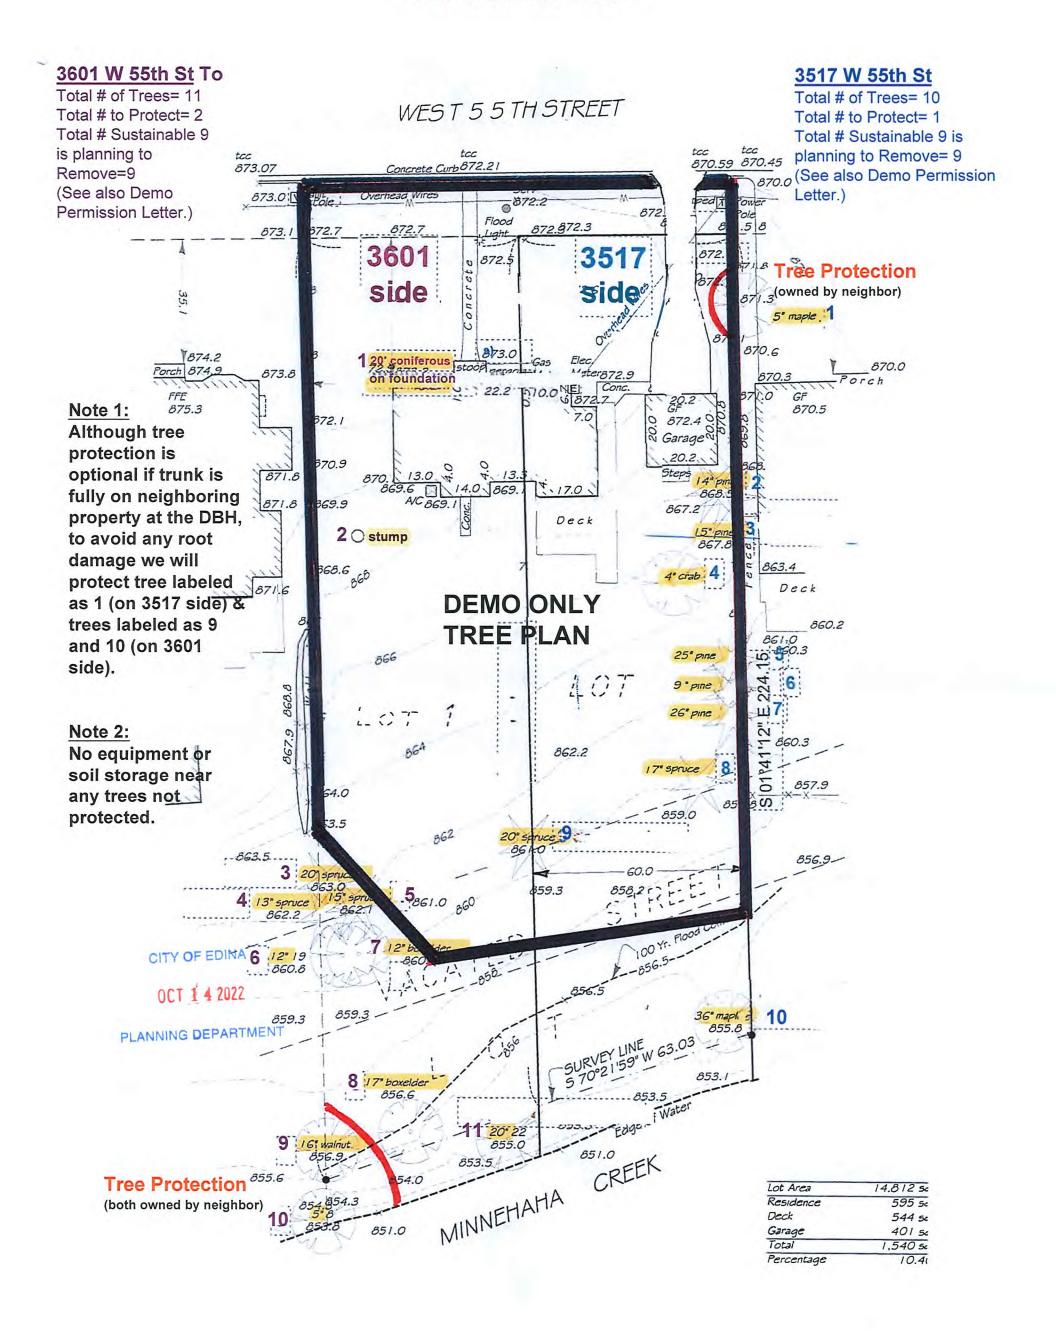



CITY OF EDINA

OCT 1 4 2022

PLANNING DEPARTMENT



CITY OF EDINA

OCT 1 4 2022

PLANNING DEPARTMENT

### \*PRE-DEMOLITION (Demo is now complete)

#### **EAST NEIGHBOR**



CITY OF EDINA

OCT 1 4 2022

PLANNING DEPARTMENT

CITY OF EDINA

OCT 1 4 2022

PLANNING DEPARTMENT

# STORMWATER MANAGEMENT PLAN

Lot 4, Block 8, Woodbury Park Near Lake Harriet

3517 West 55th Street

Edina, Minnesota

September 30<sup>th</sup>, 2022 Rev. – October 7<sup>th</sup>, 2022

Prepared By:



Prepared For:

Sustainable 9 Design & Build 3511 West 44<sup>th</sup> Street Minneapolis, Minnesota 55410

I hereby certify that this Plan, Specification or Report was prepared by me or under my direct supervision and that I am a duly Licensed Professional Engineer under the laws of the State of Minnesota.

Jeffrey A. Prasch, PE Project Engineer 52706

09.30.22

License Number

Date



#### **Table of Contents**

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2.0	Design Considerations		
3.0	Subcatchment Analysis	38	II
	Table 3.1 – Subcatchment Area Summary		ii

#### Appendix A – Figures

Figure 1 - Drainage Areas Existing Conditions Figure 2 - Drainage Areas Proposed Conditions OCT 1 4 2022

Stormwater Management Plan 3517 West 55<sup>th</sup> Street – Edina, MN Rev. – October 7<sup>th</sup>, 2022

#### 1.0 Project Overview PLANNING DEPARTMENT

A new house with driveway is being proposed at 3517 West 55<sup>th</sup> Street in the City of Edina (City). The proposed house is located on a new lot created by a lot split of Lot 1, Block 7 Woodbury Park Near Lake Harriet (3601 W 55<sup>th</sup> Street). The lot that this project is located on is the East 60 feet of the original lot, which equates to 0.34 acres. This part of the original lot contained approximately one third of the original house along with the detached garage and driveway. There is private property located to the east and west, street to the north and Minnehaha Creek creates the south boundary for the lot. Currently, most of the site flows south directly into Minnehaha creek with part of the front yard and driveway flowing to the street and a portion of the east side yard flowing east to private property. The street and private property subcatchments flow via storm sewer into Minnehaha Creek. Minnehaha Creek is considered a regional flooding issue according to the City of Edina Engineering Department. The existing drainage conditions are shown in Figure 1.

The proposed improvements include a new house with attached garage, driveway, porch, and pool with surrounding patio. Because this lot originally only supported half of a residence, there will be a large increase in impervious surface. The stormwater from these impervious surfaces will be primarily drained to the creek via a side yard swale and grading of the new driveway. This will prohibit an increase in rates to private property. **Figure 2** shows the proposed drainage conditions.

#### 2.0 Design Considerations

The site is under the jurisdiction of Minnehaha Creek Watershed District (MCWD) and the City. This project will not trigger the MCWD stormwater rule because it is the redevelopment of a single-family home. This project will trigger Category 2 of the City's Rule because it is the redevelopment of a single-family home. The on-site storm water system design is based on their guidelines:

- Rate and Volume Modeling Software HydroCAD 10.10
- ▲ Rainfall Distribution MSE 24-hour Type III
- A Rainfall Data NOAA Atlas 14 rainfall data as shown in Figure 3.
- A Soil Conditions Hydrologic Soil Group B based on web soil survey shown in Appendix D.

#### 3.0 Subcatchment Analysis

The City regulates the rate of water discharged from the site. The discharge rate requirement is no increase in peak rate to private property for the 10-yr storm event. In regards to volume control, the site does not flow to structural flooding. It does flow into the regional flooding of Minnehaha Creek. **Table 3.1** shows the existing and proposed Subcatchment Analysis .


Table 3.1 - Subcatchment Area Summary


Subcatchment	Imperviou	s Area [sf]	Total Area [sf]		
	Pre-	Post-	Pre-	Post-	
Street (1S)	313	631	1,622	1,914	
Private Property (2S)	672	0	672	471	
Minnehaha Creek (3S)	1,674	5,439	12,518	12,427	

As shown in the table above, the discharge rates to private property will not increase because of the decrease in impervious area and decrease in total area flowing to private property.

## **Appendix A**

**Figures** 

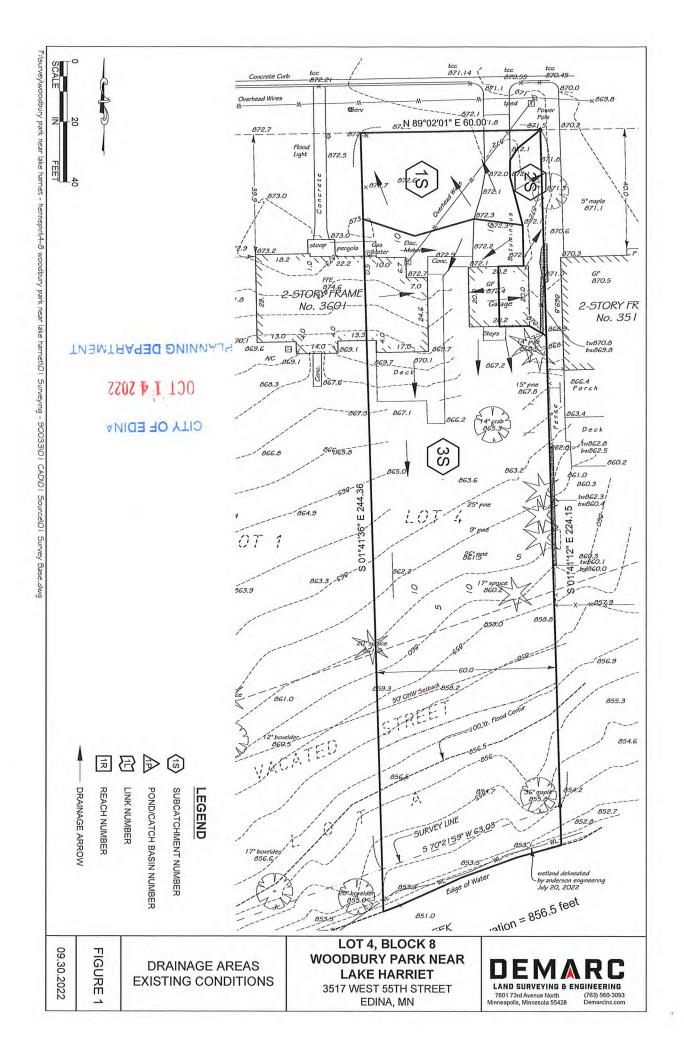

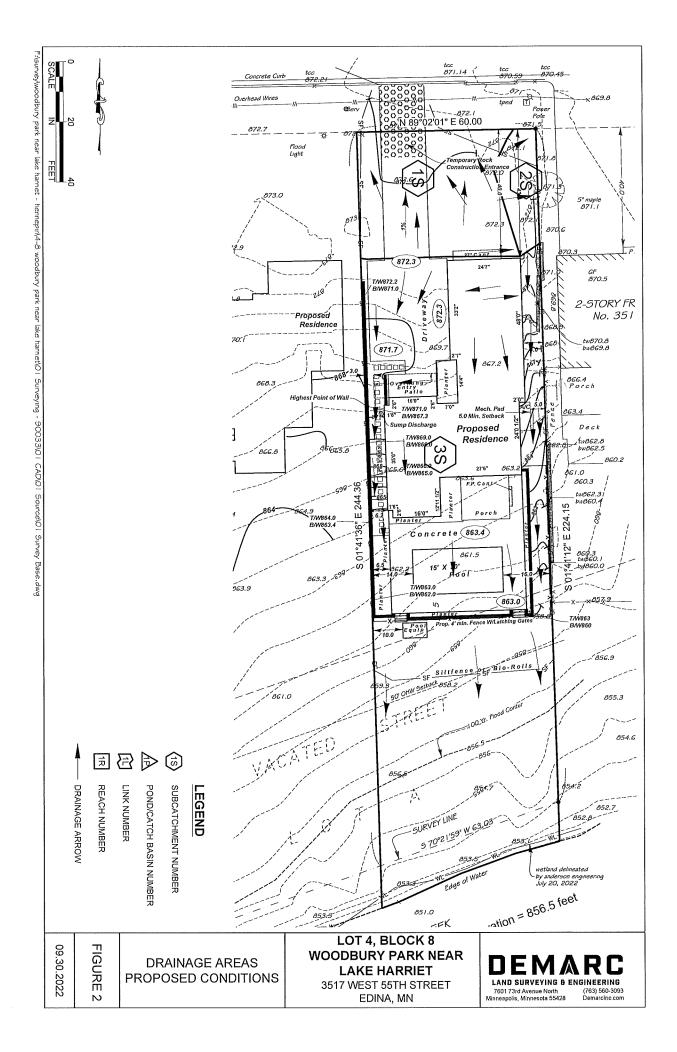

#### FIGURE 3 - PRECIPITATION DATA



. ,

NOAA Atlas 14, Volume 8, Version 2 Location name: Minneapolis, Minnesota, USA\* Latitude: 44.9126°, Longitude: -93.3445° Elevation: 919.99 ft\*\*

\* source: ESRI Maps
\*\* source: USGS



#### CITY OF EDIN ROINT PRECIPITATION FREQUENCY ESTIMATES

Sanja Perica, Deborah Martin, Sandra Pavlovic, Ishani Roy, Michael St. Laurent, Carl Trypaluk Dale Unruh, Michael Yekta, Geoffery Bonnin

OCT 1 4 2022

NOAA, National Weather Service, Silver Spring, Maryland

#### PLANNING DEPARTMENT | PF graphical | Maps & aerials

#### PF tabular

PDS-	S-based point precipitation frequency estimates with 90% confidence intervals (in inches) <sup>1</sup>									
Duration	Average recurrence interval (years)									
10000	1	2	5	10	25	50	100	200	500	1000
5-min	<b>0.353</b> (0.288-0.438)	0.419 (0.342-0.520)	<b>0.532</b> (0.432-0.662)	<b>0.630</b> (0.509-0.788)	<b>0.773</b> (0.605-1.00)	<b>0.889</b> (0.677-1.17)	1.01 (0.741-1.35)	1.14 (0.798-1.56)	1.31 (0.884-1.85)	1.45 (0.949-2.07
10-min	0.517 (0.422-0.642)	0.613 (0.501-0.762)	<b>0.778</b> (0.633-0.970)	<b>0.923</b> (0.746-1.15)	1.13 (0.886-1.47)	1.30 (0.992-1.71)	1.48 (1.09-1.98)	1.67 (1.17-2.29)	1.92 (1.30-2.71)	2.13 (1.39-3.03
15-min	0.630 (0.515-0.783)	<b>0.748</b> (0.610-0.929)	0.949 (0.772-1.18)	1.13 (0.909-1.41)	1.38 (1.08-1.79)	1.59 (1.21-2.08)	1.80 (1.32-2.42)	2.03 (1.43-2.79)	2.35 (1.58-3.31)	2.60 (1.70-3.69
30-min	0.891 (0.729-1.11)	1.07 (0.870-1.32)	1.36 (1.11-1.70)	1.62 (1.31-2.03)	2.00 (1.56-2.59)	2.30 (1.75-3.01)	<b>2.61</b> (1.92-3.50)	2.94 (2.07-4.05)	3.40 (2.29-4.79)	3.77 (2.46-5.36
60-min	1.16 (0.950-1.44)	1.39 (1.13-1.72)	1.78 (1.45-2.22)	2.15 (1.74-2.69)	2.70 (2.13-3.54)	3.17 (2.42-4.19)	3.67 (2.70-4.95)	<b>4.21</b> (2.96-5.82)	<b>4.99</b> (3.36-7.05)	<b>5.61</b> (3.66-7.98
2-hr	1.43 (1.18-1.77)	1.70 (1.40-2.10)	2.21 (1.81-2.73)	2.68 (2.18-3.33)	3.41 (2.71-4.46)	4.04 (3.12-5.32)	<b>4.73</b> (3.51-6.36)	<b>5.48</b> (3.89-7.54)	<b>6.57</b> (4.47-9.25)	<b>7.46</b> (4.90-10.5
3-hr	1.60 (1.32-1.96)	1.89 (1.56-2.33)	2.46 (2.02-3.03)	3.00 (2.45-3.71)	3.87 (3.10-5.07)	<b>4.63</b> (3.60-6.10)	<b>5.48</b> (4.09-7.36)	<b>6.41</b> (4.58-8.82)	7.78 (5.33-10.9)	<b>8.91</b> (5.89-12.5
6-hr	1.88 (1.56-2.29)	2.21 (1.83-2.70)	2.86 (2.36-3.50)	3.51 (2.88-4.31)	<b>4.56</b> (3.69-5.96)	<b>5.49</b> (4.30-7.20)	<b>6.53</b> (4.92-8.74)	<b>7.69</b> (5.54-10.5)	9.41 (6.49-13.2)	10.8 (7.21-15.1
12-hr	2.13 (1.78-2.58)	2.53 (2.11-3.06)	3.27 (2.72-3.97)	3.98 (3.29-4.86)	5,09 (4.12-6.56)	6.06 (4.76-7.85)	<b>7.11</b> (5.38-9.41)	8.28 (5.99-11.2)	9.97 (6.92-13.8)	11.4 (7.62-15.8)
24-hr	2.49 (2.09-3.00)	2.86 (2.40-3.45)	3.58 (2.99-4.32)	4,29 (3.56-5.19)	<b>5.41</b> (4.41-6.92)	6.39 (5.06-8.23)	7.49 (5.71-9.85)	8.71 (6.35-11.7)	10.5 (7.34-14.4)	12.0 (8.09-16.5
2-day	2.90 (2.45-3.46)	3.25 (2.74-3.88)	3.94 (3.31-4.72)	<b>4.63</b> (3.87-5.57)	5.76 (4.74-7.32)	6.76 (5.39-8.64)	<b>7.88</b> (6.05-10.3)	9.13 (6.72-12.2)	<b>11.0</b> (7.75-15.0)	12.5 (8.53-17.1
3-day	3.17 (2.68-3.76)	3.52 (2.98-4.19)	<b>4.23</b> (3.56-5.04)	<b>4.93</b> (4.13-5.90)	6.06 (5.00-7.66)	<b>7.07</b> (5.66-9.00)	8.20 (6.33-10.7)	9.47 (7.00-12.6)	11.3 (8.03-15.4)	12.9 (8.82-17.5
4-day	3.37 (2.87-4.00)	3.76 (3.19-4.46)	<b>4.50</b> (3.80-5.35)	<b>5.22</b> (4.39-6.23)	6.38 (5.27-8.01)	7.40 (5.93-9.36)	8.52 (6.59-11.0)	9.78 (7.24-12.9)	11.6 (8.25-15.7)	13.1 (9.02-17.8)
7-day	3.88 (3.31-4.57)	<b>4.38</b> (3.74-5.16)	<b>5.27</b> (4.48-6.23)	6.09 (5.14-7.22)	<b>7.31</b> (6.02-9.04)	8.34 (6.69-10.4)	9.44 (7.31-12.1)	10.6 (7.89-13.9)	12.3 (8.78-16.5)	13.7 (9.46-18.5
10-day	<b>4.37</b> (3.74-5,13)	<b>4.95</b> (4.24-5.82)	<b>5.96</b> (5,08-7.01)	6.83 (5.79-8.08)	8.11 (6.67-9.93)	9.15 (7.34-11.3)	<b>10.2</b> (7.93-13.0)	11.4 (8.45-14.8)	13.0 (9.26-17.3)	<b>14.2</b> (9.87-19.1
20-day	<b>5.94</b> (5.12-6.92)	6.67 (5.74-7.77)	<b>7.86</b> (6.74-9.19)	8.86 (7.56-10.4)	10.3 (8.45-12.4)	<b>11.3</b> (9.13-13.8)	<b>12.4</b> (9.67-15.5)	13.5 (10.1-17.3)	15.0 (10.8-19.7)	<b>16.1</b> (11.3-21.6
30-day	7.33 (6.34-8.50)	8.19 (7.07-9.50)	9.56 (8.23-11.1)	10.7 (9.14-12.5)	<b>12.2</b> (10.1-14.6)	13.3 (10.8-16.2)	14.5 (11.3-17.9)	15.6 (11.7-19.8)	17.0 (12.3-22.2)	18.1 (12.7-24.1)
45-day	9.13 (7.93-10.5)	10.2 (8.84-11.8)	11.9 (10.2-13.7)	<b>13.2</b> (11.3-15.3)	14.9 (12.3-17.7)	16.2 (13.1-19.5)	17.4 (13.6-21.4)	18.5 (13.9-23.4)	19.9 (14.4-25.8)	20.9 (14.8-27.7)
60-day	10.7 (9.30-12.3)	<b>12.0</b> (10.4-13.8)	13.9 (12.1-16.1)	15.5 (13.3-17.9)	17.4 (14.4-20.5)	18.8 (15.2-22.5)	<b>20.1</b> (15.7-24.6)	21.2 (16.0-26.7)	22.6 (16.4-29.2)	23.5 (16.7-31.1)

Precipitation frequency (PF) estimates in this table are based on frequency analysis of partial duration series (PDS).

Numbers in parenthesis are PF estimates at lower and upper bounds of the 90% confidence interval. The probability that precipitation frequency estimates (for a given duration and average recurrence interval) will be greater than the upper bound (or less than the lower bound) is 5%. Estimates at upper bounds are not checked against probable maximum precipitation (PMP) estimates and may be higher than currently valid PMP values.

Please refer to NOAA Atlas 14 document for more information.

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**DATE:** 10/28/2022

**TO:** Cary Teague – Planning Director

FROM: Zuleyka Marquez, PE – Graduate Engineer RE: 3601 55<sup>th</sup> St W - Subdivision Review

The Engineering Department has reviewed the subject property for street and utility concerns, grading, stormwater, erosion and sediment control and for general adherence to the relevant ordinance sections.

This review was performed at the request of the Planning Department; a more detailed review will be performed at the time of building permit application. Plans reviewed included a stormwater management plan and report, existing and proposed surveys.

#### Summary of Work

The applicant proposes a lot split to build two homes. The existing home has already been demolished.

#### Survey & Easements

The benchmark is based on a hydrant in a recent reconstruction area. The benchmark may not be accurate.

A 24" sanitary sewer main is located in the rear yard. Surveyor must show on survey. A 20'-wide easement centered on the pipe shall be provided. Recorded easement required for permit closeout.

#### Grading and Drainage

The site drains to the street and Minnehaha Creek in both the existing and proposed condition. The west side swale is reduced by 20'.

#### Stormwater Mitigation

Stormwater was reviewed and is consistent with City of Edina Building Policy SP-003 standards. A final grade as-built survey and inspection will be required to verify compliance with the approved stormwater plan.

#### Floodplain Development

The FEMA I% annual chance floodplain is located in the rear yard, with a base flood elevation of 856.0'. Thus, the lowest floor elevation is required at no less than 858.0'. The basement is proposed at 864.7'.

#### Erosion and Sediment Control

An erosion and sediment control plan was reviewed and is consistent with City of Edina Building Policy SP-002. Suggest a double row of silt fence in the rear yard due to the steep slope.

#### Street and Driveway Entrance

The applicant proposes a new driveway entrance. A driveway entrance permit will be required. The street was reconstructed in 2021. Refer to standard plates 540 and 541 for patching requirements.

#### Public Utilities

Water and sanitary is served from 55<sup>th</sup> St W. Sanitary is also available from the rear yard. A one-inch water service line from the curb stop to the dwelling is required per the City's policy SP-024.



Sewer and water connection fees shall be paid prior to building permit issuance.

#### Miscellaneous

A Minnehaha Creek Watershed District permit may be required, applicant will need to verify with the district.

Sealed wells are located onsite. Thus, coordination with Minnesota Department of Health will not be required.

Retaining walls no more than 4' are proposed. Engineering is not required.



#### **MEMORANDUM**

DATE:

July 13, 2022

TO:

Hennepin County Taxpayer Services Department

CenterPoint Energy

USPS: West Edina Carrier Annex (55424, 55436, 55439)

Edina Office (55410)

Normandale Office (55435) Chad.F.Stephan@usps.gov

Metropolitan Council Xcel Energy - Email

City of Edina: Water/Utility Department

Police Department

Planning Department Engineering Department

Voter Registration

Assessing Department

Health Department

Public Works Department

Fire Department

FROM:

David Fisher, Chief Building Official

SUBJECT:

Address Assignment change for a new lot split from one lot into two lots for

single family dwellings

Please be advised of the following address assignment: 3601 55th St W

Legal Description:

Lot Block

PID Number: 20-028-24-22-0087

20-028-24-22-0095

Old address: 3601 55th St W, Edina, MN 55424

New address: 3601 55th St W, Edina, MN 55424

3517 55th St W, Edina, MN 55424

Multiple addresses:

3601 55th St W, Edina, MN 55424

3517 55th St W, Edina, MN 55424

Reason for change:


Lot split from one lot to two lots

Additional information:

See attached info.

Please adjust your records accordingly.

1:\Building\Addresses\ADDRESS ASSIGNMENTS\2022\3601 55th St W .docx

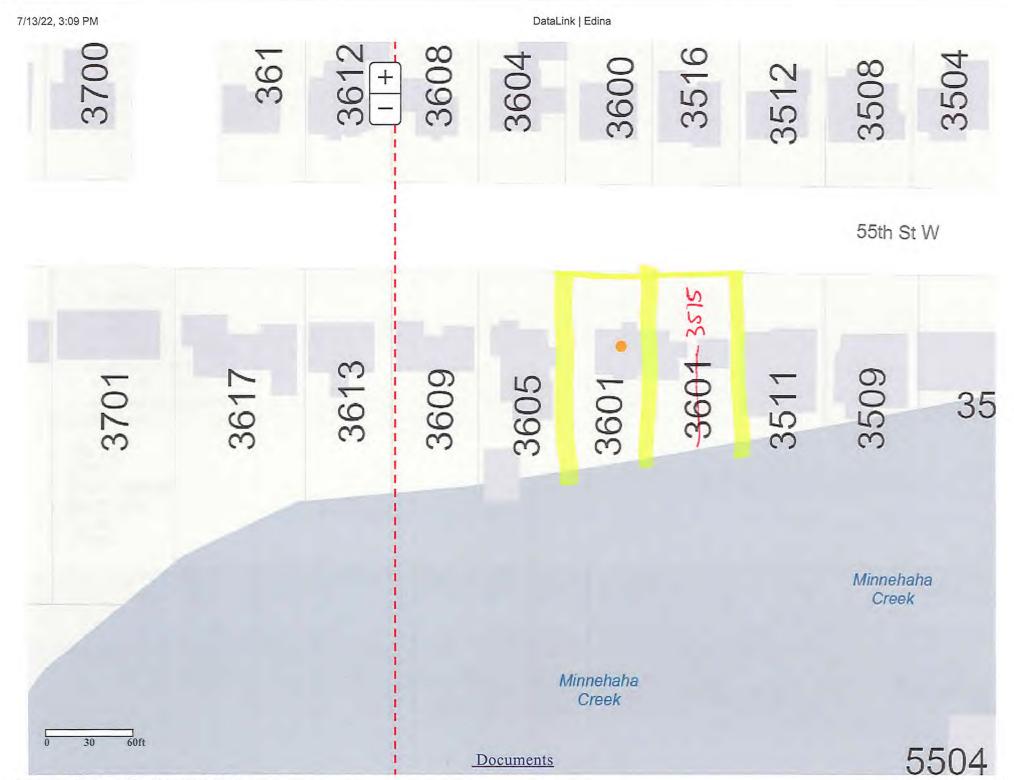

SHEET NO. 1 OF \_3\_ HENNEPIN COUNTY PROPERTY DIVISIONS PI381101 DIVISION # 210295 MUNICIPALITY: EDINA SCH DIST 273 WATERSHED 3 SEWER DIST GREEN ACRES OPEN SPACE IF PROJ # TRANS LINE/EZ INDIC DIVIDE/COMBINE:

PROPERTY ID 20-028-24 22 0087

PROPERTY ADDRESS 03601 55TH ST W

ADDITION NAME

DATE FILED ADDN#

OWNER ERICA A BERGSLAND TAXPAYER N/A ERICA A BERGSLAND 3601 55TH ST W EDINA MN 55410

WOODBURY PARK NEAR LAKE HARRIET 04/20/1926 78050

DATE OF LAST TRAN 04/30/93 LOT 001 BLOCK 007 ACREAGE 0.27 APPROX PARCEL SIZE N 60X187X63X207

METES & BOUNDS DESCRIPTION INCL ADJ 1/2 OF VAC STS

SR EX AG PT H OWN% LAND TOTAL H-BASE1 H-BASE2 N/H-BASE1 N/H TC GROSS TC BLDG MACH

PROPERTY ID 20-028-24 22 0095

PROPERTY ADDRESS 03601 55TH ST W

OWNER ERICA A BERGSLAND TAXPAYER N/A ERICA A BERGSLAND 3601 55TH ST W

ADDITION NAME WOODBURY PARK NEAR LAKE HARRIET

DATE FILED ADDN# 04/20/1926 78050

EDINA MN 55410

DATE OF LAST TRAN 04/30/93 LOT 004 BLOCK 008 ACREAGE 0.25 APPROX PARCEL SIZE N 60X168X63X187

METES & BOUNDS DESCRIPTION

INCL ADJ 1/2 OF VAC ST

TOTAL H-BASE1 H-BASE2 N/H-BASE1 N/H TC GROSS TC SR EX AG PT H OWN% LAND MACH

PI381101

HENNEPIN COUNTY

PROPERTY DIVISIONS

SHEET NO. 2 OF 3.
DIVISION # 210295

PROPERTY ID 20-028-24 22 0098

PROPERTY ADDRESS 00024 ADDRESS UNASSIGNED

OWNER ERICA A BERGSLAND TAXPAYER N/A ERICA A BERGSLAND 3601 55TH ST W EDINA MN 55410

ADDITION NAME WOODBURY PARK NEAR LAKE HARRIET

DATE FILED ADDN# 04/20/1926 78050

DATE OF LAST TRAN 04/30/93 LOT BLOCK ACREAGE 0.21

APPROX PARCEL SIZE 120 X 70

METES & BOUNDS DESCRIPTION

OF LOT 4 BLK 8 EXTENDED ACROSS LOT A INCL ADJ 1/2 OF VAC ST

SR EX AG PT H OWN% LAND BLDG MACH TOTAL H-BASE1 H-BASE2 N/H-BASE1 N/H TC GROSS TC

DIVISION/COMBINATION:


NEW PROPERTY ID'S SEC TWP RG QQ SUFX SEC TWP RG QQ SUFX SEC TWP RG QQ SUFX 20-028-24 22 0118 20-028-24 22 0119 - -

PROPERTY DIVISIONS & COMBINATIONS Municipality: (24) Edina Division No. 210295 3 Of Sheet Division Form No. HCPT03-2 (11/97) Date: 12/17/2021 03:09 Page 1 of 1 ADDRESS PENDING 20-028-24-22-0118 Owner: ERICA A BERGSLAND **Property Address** 24 Taxpayer: ERICA A BERGSLAND 3601 55TH ST W Mortgage Loan No: EDINA MN 55410 Mortgage Code: Addition No: 78050 Lot: Block: Acreage: Approx. Parcel Size: IRREGULAR INCLUDING ADJOINING HALF OF VACATED Metes & Bounds Description: STREET; AND, THAT PART OF LOT A LYING BETWEEN THE WEST LINE OF LOT 1, BLOCK 7 AND THE EAST LINE OF LOT 4, BLOCK 8 EXTENDED ACROSS LOT A, INCLUDING ADJOING HALF OF VACATED STREET, ALL IN WOODBURY PARK NEAR LAKE HARRIET. 24 ADDRESS PENDING 20-028-24-22-0119 Owner: ERICA A BERGSLAND **Property Address** Taxpayer: ERICA A BERGSLAND 3601 55TH ST W Mortgage Loan No: EDINA MN 55410 Mortgage Code: Addition No: 78050 Approx. Parcel Size: IRREGULAR Lot: Block: Acreage: INCLUDING ADJOING HALF OF VACATED Metes & Bounds Description: STREET; AND, THAT PART OF LOT A LYING BETWEEN THE EAST AND WEST LINES OF LOT 4, BLOCK 8 EXTENDED ACROSS LOT A, INCLUDING ADJOINING HALF OF VACATED STREET, ALL IN

WOODBURY PARK NEAR LAKE HARRIET.



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	PINS PRELIMINARY COVER SHEET — DIVISION-OF-DIVISION												
MUNICIPAL CODE	SCHOOL DISTRICT	Watershed District	SEWER DISTRICT	TIF PROJECT#		NEW PL	AT NAM	E LAN	D TYPE: A	. <b>●</b> T	В		DITION DDE(S)
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						J LJ	L	Check if the	re are addit	ional ID numbe	ers on next page		
NOTES:													

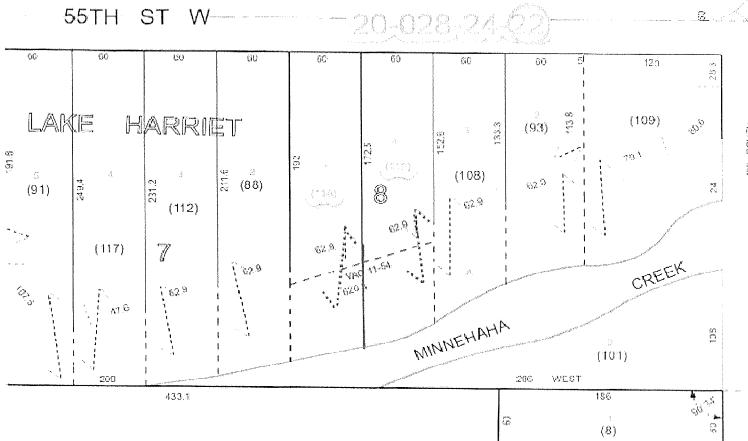

Property ID and Platting Unit Resident and Real Estate Services A-500 Government Center Minneapolis, MN 55487-0060

 $Email: \underline{RRES.PropertyID and Plats@Hennepin.us}$ Phone: 612-348-3271

	THE THE PERSON ASSESSED BY ASSESSED ASSESSED ASSESSED.		
Owner Name	Erica A. B	ergsland	
Address	3601 W	55th St.	
Phone 651-485-2835	Email	ebergslan	d@gmail.com
Mail Tax Statements To Erica A Bergs	Land 3601 W	55th St. Edina	MN 55410
hereby make a request to cha	ange the ass	sessment on t	ne following described land:
Divide Com	bine	Other _	
For City Of Edina		For Tax Year ea	rliest effective date
Property ID Numbers 2002824220087 (1)		(4)	
2002824220095			
(3)		(6)	
Additional Remarks Per submitted resolution (2020-0-	-	a) Divide and c & 2	onsolidate parcel 3 into parcels
(For add	litional ID numbers,	please add an attachi	nent)
Owner Signature			0ate 3/4/2021
Was a Survey done for this cha	ange?	Yes No	*If yes, please send a copy of the Survey with this form.*
Last Revised January 2021	THE STATE OF THE S		HC A-500 Property ID and Platting



LAND TYPE Abstract (A)
DOC NUM 10914558

Certified, filed and/or recorded on
Feb 10, 2021 10:41 AM

Office of the County Recorder

Hennepin County, Minnesota
Martin McCormick, County Recorder
Mark Chapin, County Auditor and Treasurer

Deputy 98

Pkg ID 2171010E

Document Recording Fee

\$46.00

**Document Total** 

\$46.00



## PLANNING RESOLUTION NO. 2020-04 APPROVING A LOT DIVISION FOR PARCELS AT 3601 WEST 55TH STREET

WHEREAS, the following described tract of land is requested to be divided:

## DESCRIPTION OF PROPERTY SURVEYED ORIGINAL (3) PARCELS

Lot 1, Block 7, including adjoining ½ of vacated street, Woodbury Park near Lake Harriet, Hennepin County, Minnesota.

Lot 4, Block 8, including adjoining ½ of vacated street, Woodbury Park near Lake Harriet, Hennepin County, Minnesota.

All that part of Lot A lying between the West line of Lot 1, Block 7 and the East line of Lot 4, Block 8 extended across Lot A, including adjoining ½ of vacated street, all in Woodbury Park near Lake Harriet, Hennepin County, Minnesota.

WHEREAS, the owners of the described land desires to subdivide said tract in to the following described new and separate parcels (herein called "parcels") described as follows:

### Parcel A

Lot 1, Block 7, including adjoining ½ of vacated street, Woodbury Park near Lake Harriet, Hennepin County, Minnesota.

## AND

That part of Lot A lying between the West line of Lot 1, Block 7 and the East line of Lot 4, Block 8 extended across Lot A, including adjoining ½ of vacated street, all in Woodbury Park near Lake Harriet, Hennepin County, Minnesota.

## Parcel B

Lot 4, Block 8, including adjoining ½ of vacated street, Woodbury Park near Lake Harriet, Hennepin County, Minnesota.

### AND

All that part of Lot A lying between the East and West lines of Lot 4, Block 8 extended across Lot A, including adjoining ½ of vacated street, all in Woodbury Park near Lake Harriet, Hennepin County, Minnesota.

WHEREAS, the requested lot line adjustment is authorized under Code Chapter 32 Section 32-6 and it has been determined to comply with the Subdivision and Zoning Regulations of the City of Edina and do not interfere with the Subdivision and Zoning Regulations as contained in the Edina City Code Chapter 32;

NOW THEREFORE, it is hereby resolved, that the lot division is hereby approved pursuant to City. Code Sections 32-6.

Adopted this 11th day of December 2020.

ATTEST:\_\_\_\_

Cary Teague, City Planner

I hereby certify that the attached and foregoing Resolution is a true and correct copy of the administrative approval of a lot line adjustment.

Liz Olson, Planning Division

LEGAL DESCRIPTION OF ORIGINAL PARCEL (AS SURVEYED 2001); Lot 1, Block 7, including adjoining 1/2 of vacated street, WOODHURY PARK NEAR LAKE HARRIET, Hennepin County, Minnesota. Lot 4, Block 8, including adjoining 1/2 of vacated street, WOODBURY PARK NEAR LAKE HARRIET, Hemnyin County, Minnesota. though the stand 55 TH STREET WEST All that part of Lox A lying between the West line of Lox I, Block 7 and the East line of Lot 4, Block 5 extended across Lot A, including adjoining 1/2 of vacated street, all in WOODBURY PARK NEAR LAKE HARRIET, Hennepin County, Minnesota. PROFOSED LEGAL DESCRIPTION OF PARCEL A:
Let 1, Block 7, including adjoining 1/2 of varated street, WOODBURY PARK NEAR LAKE
HARRIET, Hemelyin County, Minnesota. AND PROVE PLACE That part of Lot A lying between the East and West lines of Lot 1, Block 7 extended across Lot A, including adjoining 1/2 of varied street, all in WOODBURY PARK NEAR LAKE HARRIET, Heacepin County, Minnesota. Contains: 15,909± Sq. Ft. as measured to the edge of water at the time of survey (2001). PROPOSED LEGAL DESCRIPTION OF PARCEL B: Los 4, Block 8, including adjoining 1/2 of vacated street, WOODBURY PARK NEAR LAKE HARRIET, Hernepin County, Minnesota DESTA-AND C That purt of Lot A lying between the East and West lines of Lot 4, Block 8 extended across Lot A, including a ljoining 1/2 of vacated street, all in WOODBURY PARK NEAR LAKE HARRIET, Hencepin County, Mirnesota. Contains: 14,677± Sq. Ft. as measured to the edge of water at the time of survey (2001). Constant: 14,9778-5; P. LS measures to use edge of write it the unite to san'ty (2007).

1. Shewing a proposed for pittipe a survey completed by Jimos Parker, R.J. S. No. 9235, dotted buy §16, 2001. This survey does not puport to show existing econdition and no site visit was performed at this time.

2. Elevations the site at selected locations to give some indication of the topography of the site. We have also provided a benchmark for your use in determining circuiton for construction on this site, The elevations shown relate only to the benchmark provided on this rarvey. Use that benchmark and etches it state one other feature shows on the savery when determining other elevations for use on this site or before beginning construction. 1,0% STREET construction.

This survey has been completed without the benefit of a current title commitment. There may be astituing examents or other nonumbraness that would be revealed by a current title commitment. Therefore, this nurvey does not purport to show any electronist or monomisment other than the ones shown between. We show a proposed division of the property per your instructions. Please review the proposed division of the property per your instructions. Please review the proposed division of the property per your instructions. Please review the proposed division of the property per your instructions. Please review the appropriate division to verify that it is what you intended. We suggest you subtain this survey to be governmental agencies that have justification over it to obtain their appropriate, if you can, before making any decisions regarding the property. STANDARD SYMBOLS & CONVENTIONS:

"•" Denotes iron nurvey marker, found, unless otherwise noted. CREEK 1.0T MINNEHAHA == LOT SPLIT PRAYER DISTRICTION & SCALE

Advance Surveying & Engineering, Co.

Wagnetichs

MACO GUPTEMBER 21, 2018

MAY, 2001

MAY 25, 2001 ALREAST 14, 2016

DIWETED DATE:

PETTINE SIX H

180871 WP

**S1** 

ERICA BERGSLAND

3601 W. 55TH ST. EDINA, MN

LEGAL DESCRIPTION OF ORIGINAL PARCEL (AS SURVEYED 2001): Lot 1, Block 7, including adjoining 1/2 of vacated uneet, WOODHURY PARK NEAR LAKE, HARRIET, Hensepin County, Minnesota. Lot 4, Block 8, including adjoining 1/2 of vacated street, WOODHURY PARK NEAR LAKE HARRIET, Hemepin County, Minnesota. 55 TH STREET All that part of Lot A lying between the West line of Lot 1, Block 7 and the East line of Lot 4, Block 8 extended excess Lot A, including adjoining 1/2 of waxated street, all in WOODBURY PARK NEAR LAKE HARRIET, Hennephs County, Minnesota. WEST FROFOSED LEGAL DESCRIPTION OF PARCEL A: Lot I, Block 7, including adjoining 1/2 of vacated street, WOODBURY PARK NEAR LAKE HARRIET, Hennepin County, Minnesota. AND 10 HET PART. That put of Lot A hing between the East and West lines of Lot 1, Block 7 extended across Lot A, including adjoining 1/2 of vacated treet, all in WOODBURY PARK NEAR LAKE HARRIET, Heacepin County, Minnesota. Contains: 15,9094 Sq. Ft. as measured to the edge of water at the time of survey (2001). PROPOSED LEGAL DESCRIPTION OF PARCEL B:
Los 4, Block 8, including saliciting 1/2 of vacated street, WOODBURY PARK NEAR LAKE HARRIET, Hercepin County, Minnesota. DESTARS FOX 3 That purt of Lot A lying between the East and West lines of Lot 4, Block 8 extended serous Lot A, including adjoining 1/2 of vacated street, all in WOODBURY PARK NEAR LAKE HARRIET, Hennepin County, Minnesota. Contains: 14,6774 Sq. Ft as measured to the edge of water at the time of survey (2001).

SCOPE OF WORK & ILBITATIONS:

1. Showing a proposed to right jee a survey completed by James Parker, R.L.S. No. 9235, dated May 26, 2001. This ravey does not purport to show existing conditions and no-size with very performed at the 1000 turvey and have not been field verified. Showing a continuous contraction of the stope of the state of the Contains: 14,677± Sq. Ft. as measured to the edge of water at the time of survey (2001). ŝ STREET STANDARD SYMBOLS & CONVENTIONS:
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180871 WP

#43503 SEPTLIVEER 21, 2018

3601 W. 55TH ST. EDINA, MN



## New Addresses for Two New Lots @ 3601 W 55th St, Edina

6 messages

Paul Trieu <paultrieu@sustainable9.com>

Wed, Jul 20, 2022 at 9:08 AM


To: David Fisher < DFisher@edinamn.gov>


Cc: Vince Birdsley <vince@sustainable9.com>, Ryan Hanson <ryanhanson@sustainable9.com>, Chad Hanson <chadhanson@sustainable9.com>

**Hi David** - I'm starting a fresh email chain to address my question about the new lot numbers. On the document you sent previously, there are two different callouts for what the East lot should be numbered as.

It seems clear that the West lot will be 3601.

But for the new East lot you typed 3517 on the memo but then hand wrote 3515 on the next page...

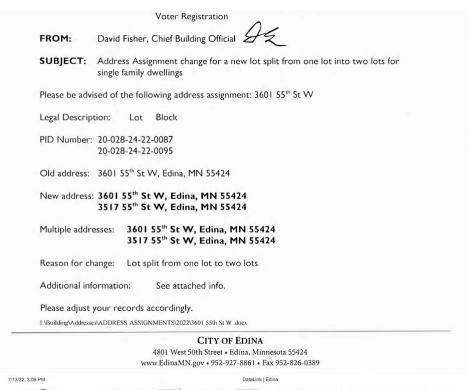

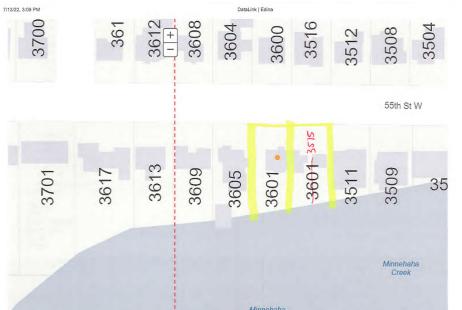

Can you please confirm which one is the correct address for the new East lot? 3515 or 3517?

Thanks,



### **Paul Trieu**

Engineer | CPHT | PDC

Sustainable 9 Design + Build

M: 952-297-5622 | O: 612-234-4194

paultrieu@sustainable9.com

Paul Trieu <paultrieu@sustainable9.com>

Tue, Aug 16, 2022 at 1:46 PM

To: David Fisher < DFisher@edinamn.gov>

Cc: Vince Birdsley <vince@sustainable9.com>, Ryan Hanson <ryanhanson@sustainable9.com>, Chad Hanson <chadhanson@sustainable9.com>

**Hey David -** Just following up on my question here regarding some confusion on what the correct new addresses are for these lots... Please confirm ASAP. Thank you!



## **Paul Trieu**

Engineer | CPHT | PDC Sustainable 9 Design + Build

M: 952-297-5622 | O: 612-234-4194

paultrieu@sustainable9.com

[Quoted text hidden]

David Fisher < DFisher@edinamn.gov>

Tue, Aug 16, 2022 at 2:18 PM

To: Paul Trieu <paultrieu@sustainable9.com>

Cc: Vince Birdsley <vince@sustainable9.com>, Ryan Hanson <ryanhanson@sustainable9.com>, Chad Hanson <chadhanson@sustainable9.com>, Jamie Ericksen <JEricksen@edinamn.gov>

Paul,

Please use the number in the letter. 3517

David



## **David Fisher, Chief Building Official**

952-826-0450 | Fax 952-826-0389

DFisher@EdinaMN.gov | EdinaMN.gov

From: Paul Trieu <paultrieu@sustainable9.com>

Sent: Tuesday, August 16, 2022 1:46 PM



## PLANNING RESOLUTION NO. 2020-04 APPROVING A LOT DIVISION FOR PARCELS AT 3601 WEST 55<sup>TH</sup> STREET

WHEREAS, the following described tract of land is requested to be divided:

## DESCRIPTION OF PROPERTY SURVEYED ORIGINAL (3) PARCELS

Lot 1, Block 7, including adjoining ½ of vacated street, Woodbury Park near Lake Harriet, Hennepin County, Minnesota.

Lot 4, Block 8, including adjoining ½ of vacated street, Woodbury Park near Lake Harriet, Hennepin County, Minnesota.

All that part of Lot A lying between the West line of Lot 1, Block 7 and the East line of Lot 4, Block 8 extended across Lot A, including adjoining ½ of vacated street, all in Woodbury Park near Lake Harriet, Hennepin County, Minnesota.

WHEREAS, the owners of the described land desires to subdivide said tract in to the following described new and separate parcels (herein called "parcels") described as follows:

## Parcel A

Lot 1, Block 7, including adjoining ½ of vacated street, Woodbury Park near Lake Harriet, Hennepin County, Minnesota.

## AND

That part of Lot A lying between the West line of Lot 1, Block 7 and the East line of Lot 4, Block 8 extended across Lot A, including adjoining ½ of vacated street, all in Woodbury Park near Lake Harriet, Hennepin County, Minnesota.

## Parcel B

Lot 4, Block 8, including adjoining ½ of vacated street, Woodbury Park near Lake Harriet, Hennepin County, Minnesota.

## AND

All that part of Lot A lying between the East and West lines of Lot 4, Block 8 extended across Lot A, including adjoining ½ of vacated street, all in Woodbury Park near Lake Harriet, Hennepin County, Minnesota.

WHEREAS, the requested lot line adjustment is authorized under Code Chapter 32 Section 32-6 and it has been determined to comply with the Subdivision and Zoning Regulations of the City of Edina and do not interfere with the Subdivision and Zoning Regulations as contained in the Edina City Code Chapter 32;

NOW THEREFORE, it is hereby resolved, that the lot division is hereby approved pursuant to City Code Sections 32-6.

Adopted this 11th day of December 2020.

Cary Teague
Cary Teague, City Planner

I hereby certify that the attached and foregoing Resolution is a true and correct copy of the administrative approval of a lot line adjustment.

Liz Olson
Liz Olson, Planning Division

LEGAL DESCRIPTION OF ORIGINAL PARCEL (AS SURVEYED 2001): Lot 1, Block 7, including adjoining 1/2 of vacated street, WOODBURY PARK NEAR LAKE HARRIET, Hennepin County, Minnesota.

Lot 4, Block 8, including adjoining 1/2 of vacated street, WOODBURY PARK NEAR LAKE HARRIET, Hennepin County, Minnesota.

All that part of Lot A lying between the West line of Lot 1, Block 7 and the East line of Lot 4, Block 8 extended across Lot A, including adjoining 1/2 of vacated street, all in WOODBURY PARK NEAR LAKE HARRIET, Hennepin County, Minnesota.

PROPOSED LEGAL DESCRIPTION OF PARCEL A:
Lot 1, Block 7, including adjoining 1/2 of vacated street, WOODBURY PARK NEAR LAKE HARRIET, Hennepin County, Minnesota.

That part of Lot A lying between the East and West lines of Lot 1, Block 7 extended across Lot A, including adjoining 1/2 of vacated street, all in WOODBURY PARK NEAR LAKE HARRIET, Hennepin County, Minnesota.

Contains: 15,909± Sq. Ft. as measured to the edge of water at the time of survey (2001).

PROPOSED LEGAL DESCRIPTION OF PARCEL B: Lot 4, Block 8, including adjoining 1/2 of vacated street, WOODBURY PARK NEAR LAKE HARRIET, Hennepin County, Minnesota.

That part of Lot A lying between the East and West lines of Lot 4, Block 8 extended across Lot A. including adjoining 1/2 of vacated street, all in WOODBURY PARK NEAR LAKE HARRIET, Hennepin County, Minnesota.


Contains: 14,677± Sq. Ft. as measured to the edge of water at the time of survey (2001).

### SCOPE OF WORK & LIMITATIONS:

- Showing a proposed lot split per a survey completed by James Parker, R.L.S. No. 9235, dated May 26, 2001. This survey does not purport to show existing conditions and no site visit was performed at this time.
- Elevations shown hereon are per 2001 survey and have not been field verified Showing elevations on the site at selected locations to give some indication of the topography of the site. We have also provided a benchmark for your use in determining elevations for construction on this site. The elevations shown relate only to the benchmark provided on this survey. Use that benchmark and check at least one other feature shown on the survey when determining other elevations for use on this site or before beginning construction.
- This survey has been completed without the benefit of a current title commitment. There may be existing easements or other encumbrances that would be revealed by a current title commitment. Therefore, this survey does not purport to show any casements or encumbrances other than the ones shown hereon.
- We show a proposed division of the property per your instructions. Please review the proposed division to verify that it is what you intended. We suggest you submit this survey to the governmental agencies that have jurisdiction over it to obtain their approvals, if you can, before making any decisions regarding the property.


STANDARD SYMBOLS & CONVENTIONS:

"•" Denotes iron survey marker, found, unless otherwise noted.

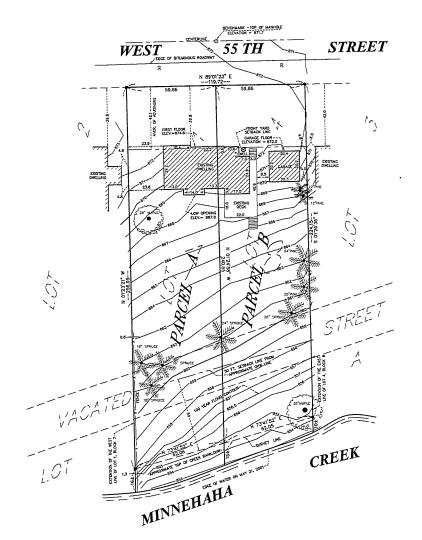


DATE	REVISION DESCRIPTION	DRAWING ORIENTATION & SCALE	CLIENT/JOB ADDRESS	///A 1	I HEREBY CERTIFY THAT THIS PLAN, SURVEY OR REPORT WAS PREPARED BY ME OR UNDER MY DIRECT SUPERVISION	SURVEYED DATE:	SHEET TITLE	SHEET NO.
8/14/18	TO SHOW PROPOSED LOT SPLIT	Λ	rnrat prodar tiro	<b>Advance</b>	AND THAT I AM A DULY RECISTERED LAND SURVEYOR UNDER THE LAWS OF THE STATE OF-MINNESOTA.		LOT SPLIT	
9/13/18	TO SHOW UPDATED IMPROVEMENTS	$\Lambda$	ERICA~BERGSLAND	Surveying & Engineering, Co.	$  \mathcal{L}_i   \mathcal{L}_i$	MAY, 2001		$\sim$ 4
		-( <sub>N</sub> )-	OCOA III. FEMIL OM	Surveying & Engineering, Co.	Wagnetowns	DRAFTED DATE:	SHEET SIZE: 22 X 34	
		T 1	3601 W. 55TH ST.	17917 Highwey No. 7	#43503		DRAWING NUMBER	
			EDINA, MN	Minnetonka, Minnesota 55345 Phone (852) 474-7964	SEPTEMBER 27, 2018	MAY 26, 2001 AUGUST 14, 2018	180871 WP	
				Web: www.edysur.com	DATE		100071 771	SHEET 1 OF 1

## 3517 & 3601 55th St W

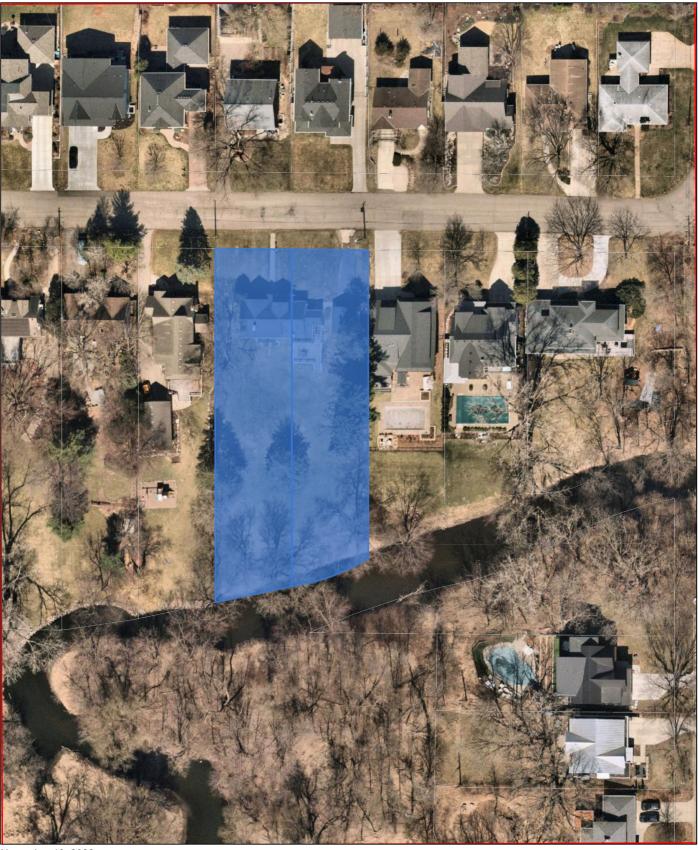

November 10, 2022

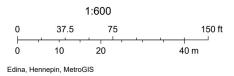

## Survey Responses

## **Public Hearing Comments**

# Better Together Edina

Project: Public Hearing: 3517 & 3601 55th Street West




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С	CONTRIBUTOR	S	RESPONSES			
<b>O</b> Registered	<b>O</b> Unverified	<b>O</b> Anonymous	<b>O</b> Registered	<b>O</b> Unverified	<b>O</b> Anonymous	

No Responses



## Lot width variances

3601 and 3517 West 55th Street

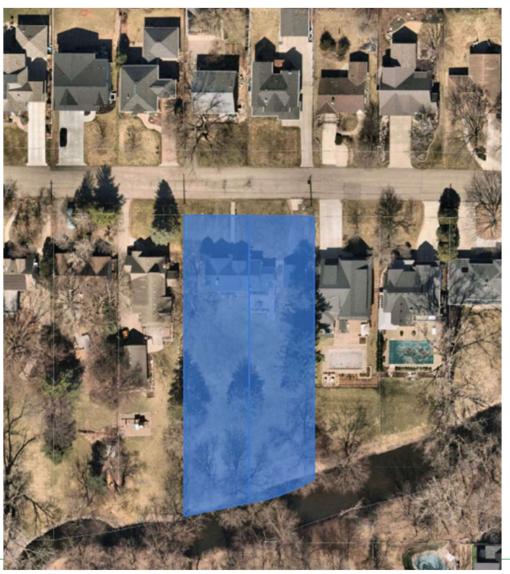




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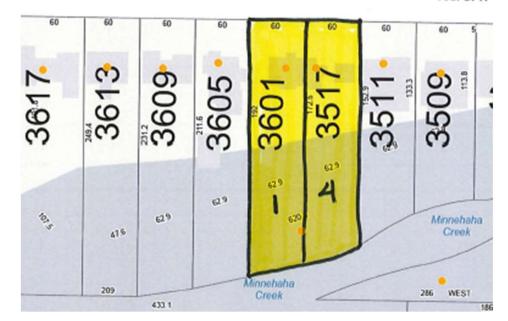


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55th St W




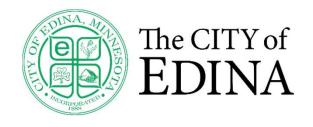

## **Lot Dimensions**

	Area	Lot Width	Depth	Street Frontage
REQUIRED	9,000 s.f.	75 feet	120 feet	30 feet
Lot I – 3601 55th	15,260 s.f.	60 feet*	254 feet	60 feet
Lot 4 – 3517 55th	14,812 s.f.	60 feet*	234 feet	60 feet

<sup>\*</sup>Variance Required

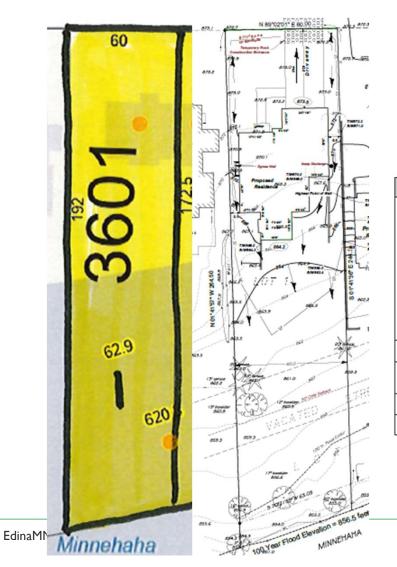




## Compliance Table-3601 West 55th Street

	City Standard	Proposed
North Side – Front Yard	37.6 feet	\ 42.6 feet
West Side – Side Yard	12 feet total, with no less than 5 feet on one side	6 feet
South Side — Rear Yard	50 feet from OHWM	Greater than 50 feet
East Side – Side Yard	12 feet total, with no less than 5 feet on one side	6.6 feet
Building Height	30 feet	26.5 feet
Building Coverage Lots greater than 9,000sf	25%	15.83%
Impervious Surface Coverage	50%	22.85%
First Floor Elevation	876.4	875.2





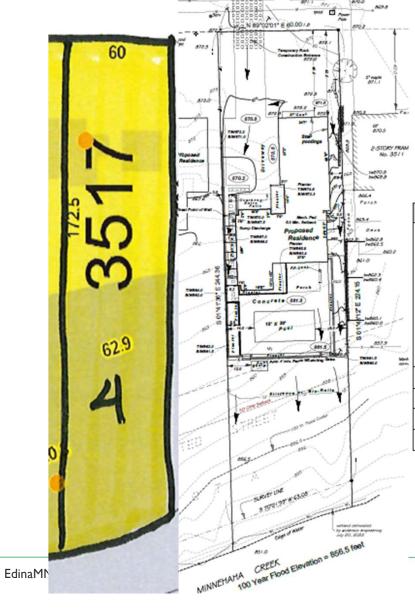



## Compliance Table-3517 West 55th Street


	City Standard	Proposed
North Side – Front Yard	37.6 feet	\ 40 feet
West Side – Side Yard	12 feet total, with no less than 5 feet on one side	6 feet
South Side – Rear Yard	50 feet from OHWM	Greater than 50 feet
East Side – Side Yard	12 feet total, with no less than 5 feet on one side	6.2 feet
Building Height	30 feet	29.42 feet
Building Coverage	25%	23.18%
Impervious Surface Coverage	50%	40.98%
First Floor Elevation	876.4	872.56










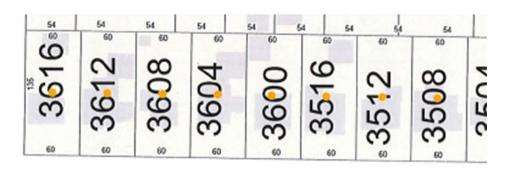



55th St W

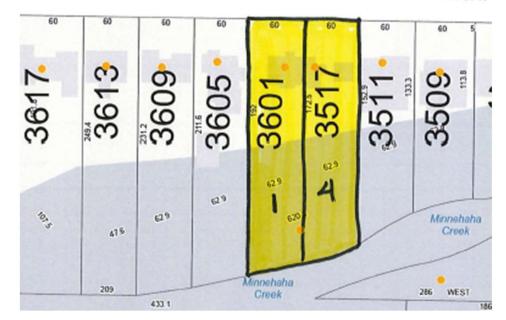

EdinaMN.gov II



# Requests need two separate motions:

One for each property address: 360 land 3517 55th Street













EdinaMN.gov 18



EdinaMN.gov 19



EdinaMN.gov 20

**Date:** November 16, 2022 Agenda Item #: VI.B.

To: Planning Commission Item Type:

Report and Recommendation

From: Kris Aaker, Assistant Planner

**Item Activity:** 

Action

**Subject:** B-22-21: A 9.55 foot front yard setback and a 9.6 foot

1st floor height variance request for 4905 Sunnyslope

Rd

#### **ACTION REQUESTED:**

Deny the variance request based on findings as stated within the staff report.

#### INTRODUCTION:

A 9.55-foot front yard setback variance from Hilltop Lane to allow a new home 34.6 feet from the property line instead of matching the average existing front yard setback of the adjacent neighboring properties of 44.15 feet. They are also requesting a 9.6-foot 1<sup>st</sup> floor height variance to allow a reorientation of the house from 4905 Sunnyslope to Hilltop Lane. The goal is to reorient the new home on a through lot to face Hilltop Lane instead of Sunnyslope Rd.

#### **ATTACHMENTS:**

Staff Report

Engineering Memo

Site Location

Narrative

Plans

SWMP

Better Together Public Hearing Comment Report

Staff Presentation

### STAFF REPORT



Date:

November 16, 2022

To:

PLANNING COMMISSION

From:

Kris Aaker, Assistant City Planner

Subject:

B-22-21, the applicant is requesting a 9.6-foot, I<sup>st</sup> floor height variance to allow a reorientation of the house from 4920 East Sunnyslope Road to Hilltop Lane. They are also requesting a 9.55-foot front yard setback variance from Hilltop Lane to allow a new home 34.6 feet from the property line instead of matching the average existing front yard setback of the adjacent neighboring properties of 44.15 feet.

#### Information / Background:

The subject property, 4920 E. Sunnyslope is a through lot located between Sunnyslope East and Hilltop Lane. The existing home on the subject property is a two-story home with an attached three-car attached garage that was built in 1941. The existing home orients towards Sunnyslope East with the rear lot backing up to Hilltop Lane.

The applicant is requesting a 9.55-foot first floor height elevation variance to allow for a new home to be built with a first floor 10.55 feet higher than the first floor of the existing house on site. The proposed new home will be oriented at a higher elevation facing towards Hilltop Lane thus the need for a 1<sup>st</sup> floor variance.

A 9.55-foot front yard setback variance from Hilltop Lane is also requested to allow a new home 34.6 feet from the property line instead of matching the average existing front yard setback of the adjacent neighboring properties of 44.15 feet.

With exception of the first-floor elevation and front yard setback, the proposed project meets all other zoning requirements.

#### **Surrounding Land Uses**

Northerly: Single Unit residential homes zoned R-I and guided low-density residential

Easterly: Single Unit residential homes; zoned R-I and guided low-density residential.

Southerly: Single Unit residential homes; zoned R-I and guided low-density residential. Westerly: Single Unit residential homes; zoned R-I and guided low-density residential.

#### **Existing Site Features**

The subject property, 4920 Sunnyslope E, was built in 1941. The lot is 20,879 square feet and is located on west side of Sunnyslope East, and east of Hilltop Lane. The existing house is oriented towards Sunnyslope and has a three-car attached garage that has access from Sunnyslope. The property slopes to higher elevations from Sunnyslope East to Hilltop Lane.

#### **Trees**

The applicant included a tree plan with variance submittal. The property has several large trees. The city recently amended its tree ordinance to require that removed trees be replaced. The ordinance does not take effect until January I, 2023. However, because there are variances being requested, and to minimize impacts to the neighborhood, staff would recommend a condition of approval be that the new ordinance must be met, with trees being replaced on the site per recommendation of the City Forester. A full review by the Forester of the tree preservation plan would take place at the time of a building permit for a new home.

#### **Planning**

Guide Plan designation: Low Density Residential

Zoning: R-I, Single Dwelling Unit District

#### **Compliance Table**

	City Standard	Proposed
North Side – Front Yard	I0 feet	40. feet
West Side – Side Yard	44.15 feet	*34.6 feet
South Side – Rear Yard	IO feet	II.8 feet
East Side — Side Street	25 feet	25 feet
Building Height	40 feet	34.6 feet
Building Coverage Lots greater than 9,000sf	25%	22.19%
First Floor Elevation	926.4'	936*

<sup>\*</sup>Requires a variance

#### **Engineering**

The Environmental Engineer has reviewed the application and submitted comments as attached in their November 10, 2022, memorandum. Stormwater was reviewed and is consistent with City of Edina Building Policy SP-003 standards. Drainage area maps are required for permit. A final grade as-built survey and inspection will be required to verify compliance with the approved stormwater plan. The proposed plan maintains drainage towards Sunnyslope Rd E but does so by channelizing runoff along the side yards with swales.

#### PRIMARY ISSUES & STAFF RECOMENDATION

#### **Primary Issue**

Is the proposed variance justified?

Minnesota Statues and Edina Ordinances require that the following conditions must be satisfied affirmatively to grant a variance. The proposed variance will not:

I) Relieve practical difficulties that prevent a reasonable use from complying with ordinance requirements.

Reasonable use does not mean that the applicant must show the land cannot be put to any reasonable use without the variance. Rather, the applicant must show that there are practical difficulties in complying with the code and that the proposed use is reasonable. "Practical difficulties" may include functional and aesthetic concerns.

The proposed use is permitted in the R-I Single Dwelling Unit District and complies with zoning standards, with exception of the first-floor elevation and front yard setback. The reason for the first-floor elevation variance request is due to the proposed new home being oriented off Hilltop Lane, which is at a higher elevation than Sunnyslope Road East. The front yard setback will match the front yard setback of the neighbor to the south, but not the average of the adjacent neighboring homes as required by ordinance. The new home is not required to be reoriented towards Sunnyslope East and can maintain required front yard setback if reoriented. Reasonable use of the property can be accomplished without the need for the two variances. The existing home is reasonable use of the site.

2) There are circumstances that are unique to the property, not common to every similarly zoned property, and that are not self-created?

The property is unique in the fact that there are street frontages on two sides of the lot. The existing house is oriented towards East Sunnyslope. There is an elevation difference between Sunnyslope and Hilltop Lane preventing a re-orientation without a variance. The applicant would like to orient the new home towards Hilltop Lane to match the exiting house to the southeast which was also reoriented from Sunnyslope East in 2014. The property owner cannot raise the house so it can be oriented towards Hilltop Lane without a variance.

The front yard setback required is 44.15 feet, which is the average front yard setback of the adjacent homes. The zoning ordinance requires a new home take into consideration the existing setbacks of adjacent or nearby homes to maintain the existing character along the streetscape. A new home fronting Hilltop Lane can maintain the required front yard setback. The front yard setback is a design choice, is self-created based on the proposed 87.5-foot depth of the house and not based on existing lot characteristics.

#### 3) Will the variance alter the essential character of the neighborhood?

Granting the variance may alter the character of the neighborhood given the reorientation and front yard setback variance requested. Although there are other homes along Hilltop in the neighborhood, the proposed new home will be reoriented towards Hilltop from Sunnyslope and will be 9.55 feet closer to the front lot line than the existing homes on either side of the subject property. The lot can accommodate a conforming home facing Sunnyslope East. A reoriented home can be designed to conform to the required front yard setback from Hilltop Ln.

#### **Optional Actions**

A case can be <u>made for approval and denial</u> of this project. Below provides options for the planning commission to consider:

#### **Approval**

Approve the request for a 9.6-foot first floor elevation and a 9.55-foot front yard setback variance for a new house at 4920 Sunnyslope East. Approval is based on the following findings:

- I. The practical difficulty is caused by the elevation change on the lot. The house needs to be raised to reorient the house.
- 2. There are circumstances that are unique to the subject property. Those unique circumstances include the elevation change on the lot and having two street frontages.
- 3. The proposal would not alter the essential character of the neighborhood. The new home is a single-story walk-out. Adjacent homes are two stories or multi-level. Orientation around the cul-desac will not negatively impact the streetscape the neighbor to the south is 6 inches closer to Hilltop at 34 feet than the proposed home at 34.6 feet.

Approval shall be subject to the following conditions:

- 1. Subject to plans and survey date stamped, October 27, 2022.
- 2. Subject to compliance with the Engineering memo dated November 10, 2022.
- 3. Subject to compliance with the new tree ordinance, with trees being replaced on the site per recommendation of the city Forester.

#### **Denial**

Deny the request for a 1-foot first floor elevation variance and front yard setback variance for a new home at 4920 Sunnyslope East. Denial is based on the following findings:

1. The proposal does not meet the standards for variance.

2. Due to the size of lot, a new home could be constructed on the property that that could meet the required setbacks and zoning requirements.

3. There is no practical difficultly preventing construction of a new home. A new home could be built and may not require a variance. A new home is not required to be reoriented towards Hilltop Lane. If granted a 1st floor height variance for a new home to be re-oriented to Hilltop, the home can be built without the need for a front yard setback variance.

#### **Staff Recommendation**

Staff cannot support the re-orientation of the home to Hilltop Lane with the requested 9.6-foot first floor height variance and the 9.55-foot front yard setback variance from Hilltop Lane given the ability to comply with the code. A compliant house may be built on the property. Staff recommends denial of the variance application for a new house reorientation to Hilltop Lane from 4920 East Sunnyslope Road.

**Deadline for a City Decision:** December 26, 2022



**DATE:** | 11/10/2022

**TO:** Cary Teague – Planning Director

FROM: Zuleyka Marquez, PE – Graduate Engineer
RE: 4920 Sunnyslope Rd E - Variance Review

The Engineering Department has reviewed the subject property for street and utility concerns, grading, stormwater, erosion and sediment control and for general adherence to the relevant ordinance sections.

This review was performed at the request of the Planning Department; a more detailed review will be performed at the time of building permit application. Plans reviewed included existing and proposed surveys and stormwater modeling.

#### Summary of Work

The applicant proposes to demolish the existing home and build a new home. The rebuild would reorient the front of the home from Sunnyslope Rd E to Hilltop La. The request is for a variance to main floor elevation increase limit and front yard setback.

#### Easements

No comment.

#### Grading and Drainage

The existing site drains from Hilltop Lane towards Sunnyslope Rd E. A retaining wall around the rear of the house helped manage the upland flow directed towards the house by flattening the area adjacent to the home. The proposed plan maintains drainage towards Sunnyslope Rd E but does so by channelizing runoff along the side yards with swales.

#### Stormwater Mitigation

Stormwater was reviewed and is consistent with City of Edina Building Policy SP-003 standards. Drainage area maps are required for permit. A final grade as-built survey and inspection will be required to verify compliance with the approved stormwater plan.

#### Floodplain Development

The site well above the local 1% annual chance floodplain elevation. No issues with the lowest opening elevation.

#### Erosion and Sediment Control

An erosion and sediment control plan was reviewed and is consistent with City of Edina Building Policy SP-002.

#### Street and Driveway Entrance

The applicant proposes to relocate the existing curb cut from Sunnyslope Rd E to Hilltop La. A driveway entrance permit will be required. Bituminous curb will be required to along Sunnyslope Rd E to match existing. Sunnyslope Rd E and Hilltop La were reconstructed in 2005. Refer to standard plates 540 and 543 for patching requirements.



#### Public Utilities

Water and sanitary is served from Sunnyslope Rd E. Sanitary is also available on Hilltop La. A one-inch water service line from the curb stop to the dwelling is required per the City's policy SP-024.

#### Miscellaneous

A Minnehaha Creek Watershed District permit may be required, applicant will need to verify with the district.


Water connection permit dated 1956. Structure built 1941. A well is likely located onsite. Thus, coordination with Minnesota Department of Health will be required.

Tiered retaining walls are proposed on the west side. Tiered retaining wall systems greater than 4-feet may require the applicant will be required to submit drawings, cross-section, and calculations prepared and signed by a Minnesota licensed professional engineer. To avoid this requirement, the applicant must demonstrate sufficient separation (2 times the height of the lower wall) between each wall to be considered independent (i.e. no surcharge from upper wall onto lower wall).

## 4920 Sunnyslope E



November 7, 2022

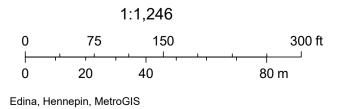

Variance Request for 4920 Sunnyslope Road

October 26<sup>th</sup> 2022

We are proposing tearing down and building new on 4920 Sunnyslope Road. The goal of the project is to construct a new home that orients to Hilltop Lane rather than Sunnyslope Road.

The first variance we are requesting is a variance to raise the main floor more than one foot [Sec. 36-439. – Special requirements (7)]. Our request would be to raise it 10.6 feet above the existing main floor height. A variance of 9.6'.

The second variance we are requesting is a variance to the established front street setback [Sec. 36-439. – Special requirements (1)]. Our request would be to adjust the front setback from 44.15' (average of the two neighbors) to 34.6'. A variance of 9.55'.

The property at 4920 Sunnyslope Road is unique and challenging. It is a thru lot that has frontage on both Sunnyslope Road to the north and Hilltop Lane to the south. Between the two property lines the lot has an elevation change of 31 feet. Due to this elevation change the current home, which is situated facing Sunnyslope Road, has a steep driveway leading to a tuck under garage. To reach the main level there are several steps before you reach an elevated stoop. The driveway is carved out of the hill with retaining walls to the west and north (some of which are on the neighboring property). The driveway also feeds into Sunnyslope at a bend in the road which makes entering and exiting more hazardous. All the yard space on the south side of the house is created using a tall retaining wall cut into the hill in order to create a flat area and minimal drainage away from the house. The neighboring home to the east is a newer build that was granted a variance for doing the same type of build that we are proposing (flipping from Sunnyslope to Hilltop). The home to the west is also a newer build but is oriented in the far northwest corner of the lot with a long driveway and a good amount of vegetation in the front shielding it from the street. Due to this unusual placement, it distorts the average streetside setback for this lot.

The owners of the property are proposing flipping the orientation of the home to the high part of the lot (Hilltop Lane) and building a new home that better fits the unique properties of the lot. We are proposing adjusting the main floor elevation from 925.4' (existing) to 936.0'. If granted, this would allow the house a more traditional layout with the garage being on the same level as the main floor. With this orientation the homeowners can better navigate the home with fewer steps to get thru the main living spaces. This also allows the basement to have full window and walkout ability on the north side. We are also proposing matching the streetside setback of the home to the east (34.3') which is placed at a more traditional location from the street. If granted, this would allow the proposed house a level driveway that provides a natural drainage path around the house. It also keeps the house at the same relative distance as the two neighboring homes and creates a unified look at the end of the cul-desac.

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The proposed variance will relieve practical difficulties (excessive grade change and a-typical house placement) in complying with the zoning ordinance and the use (single family home) is reasonable.

The proposed variance will correct extraordinary circumstances (large natural elevation variations and unique neighboring home placements) applicable to this property but not applicable to other property in the vicinity.

The proposed variance will be in harmony with the general purposes and intent of the zoning ordinance. The idea of the streetside average is to have a unified look along a street which the proposed streetside setback creates with the neighboring homes at the end of the cul-de-sac. If the new home were built with an orientation toward Sunnyslope Road the setback from Hilltop Lane would be allowed at only 25' not the 34.6' we are proposing. Raising the elevation of the main floor is in keeping with the neighboring properties on Hilltop Lane and creates a house that better fits the scale of the surrounding homes.

The proposed variance will not alter the essential character of the neighborhood. If granted, the variances will allow the new home to better fit with the neighboring properties and greater neighboring area.

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architecture

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### Coughlin

3D Conceptual Illustration

0-26-22 Rev 2

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OCT 27 2022


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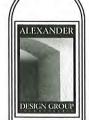
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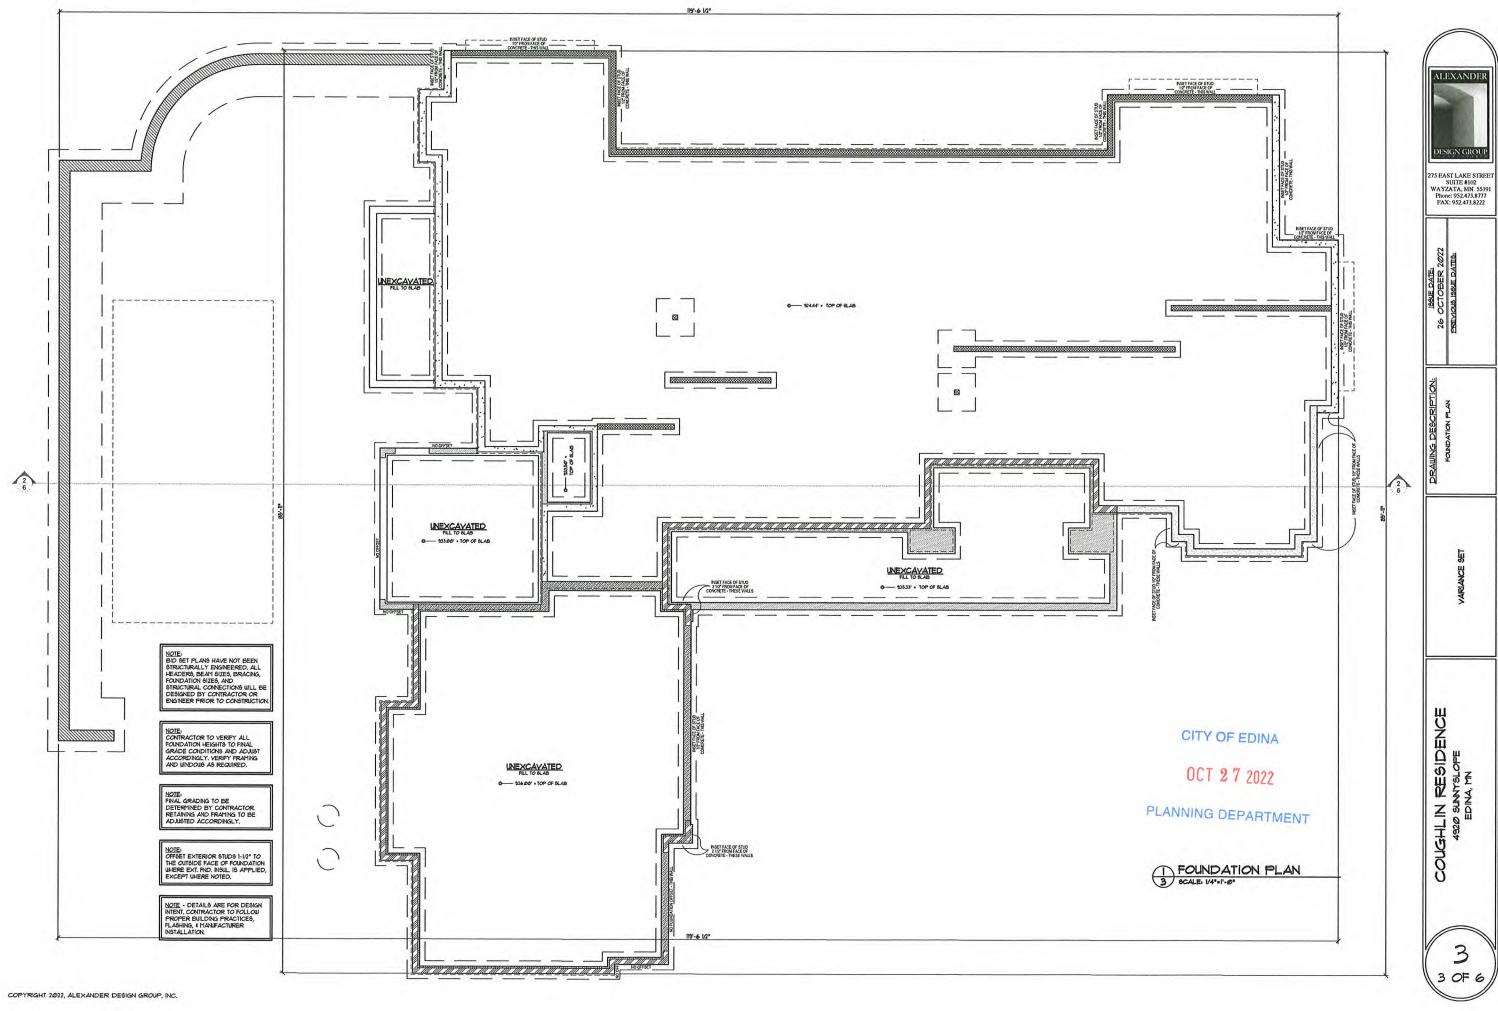
275 EAST LAKE STREET SUITE #102 WAYZATA, MN 55391 Phone: 952.473.8777 FAX: 952.473.8222


COUGHLIN RESIDENCE 4920 SUNTSLOFE EDINA, TIN


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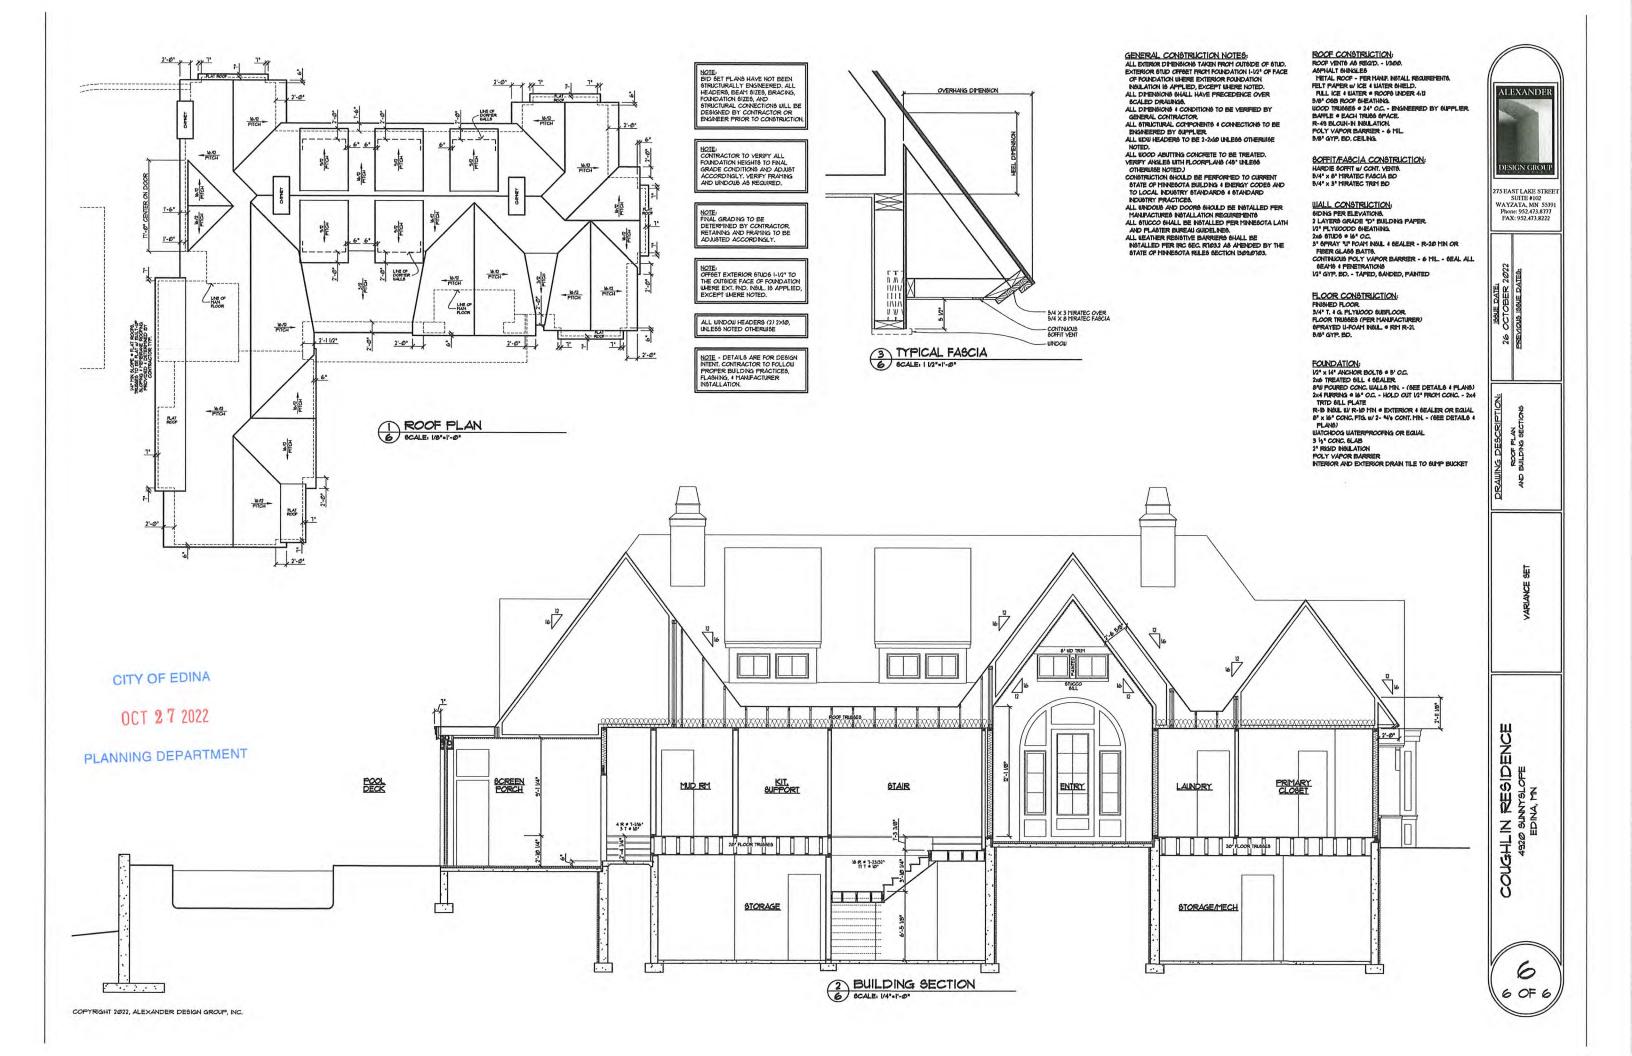
PLANNING DEPARTMENT







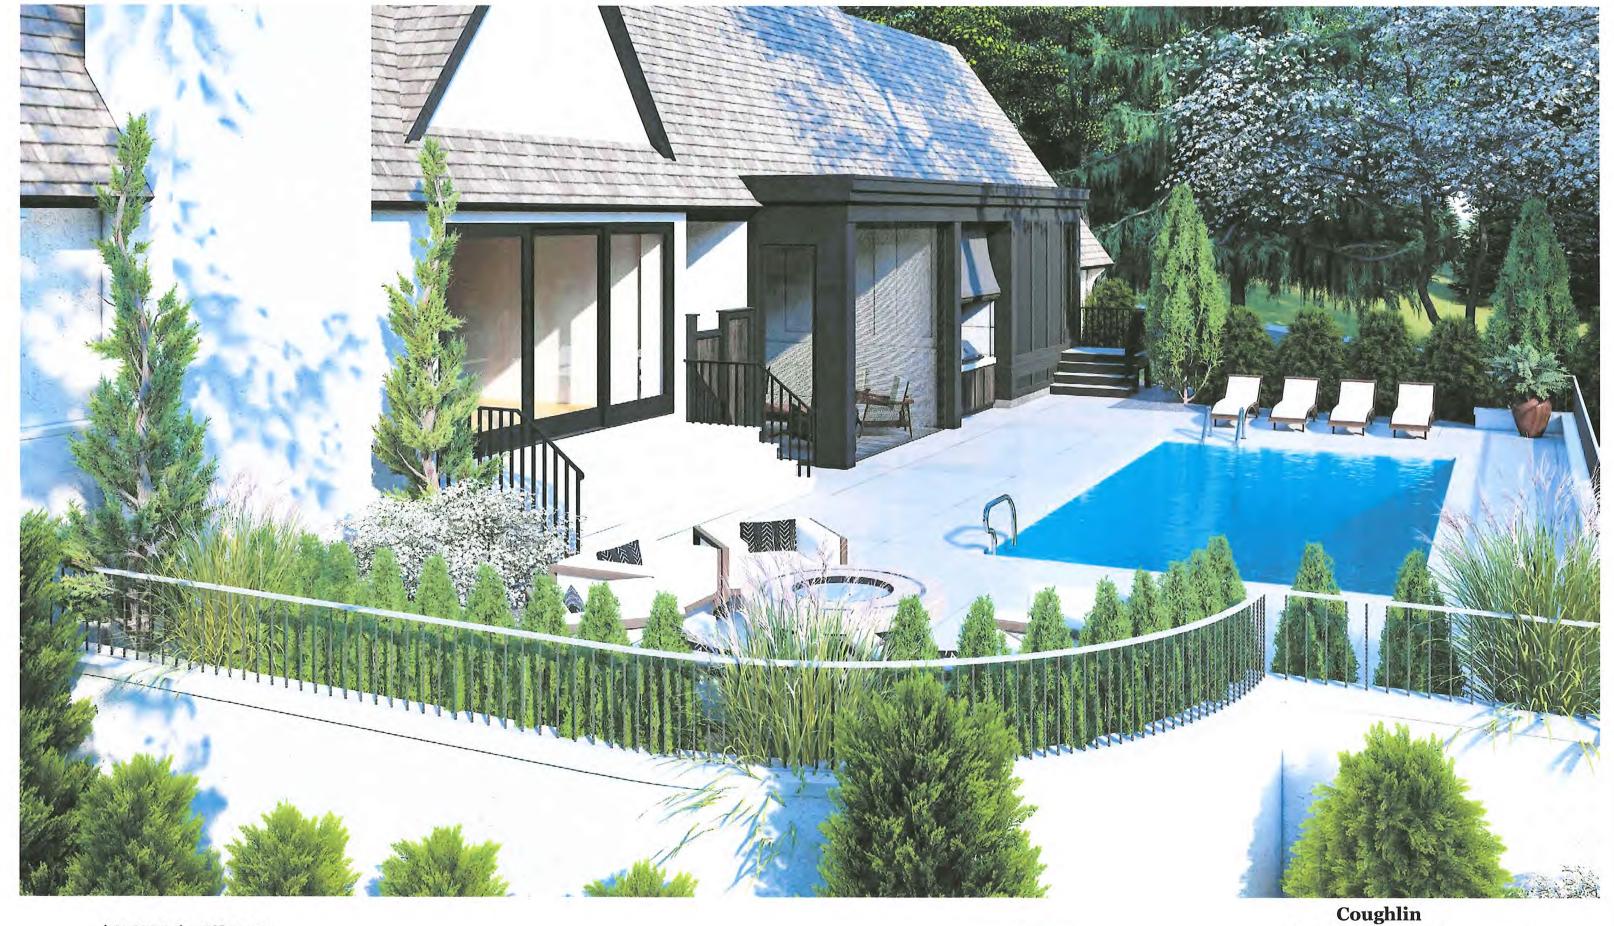

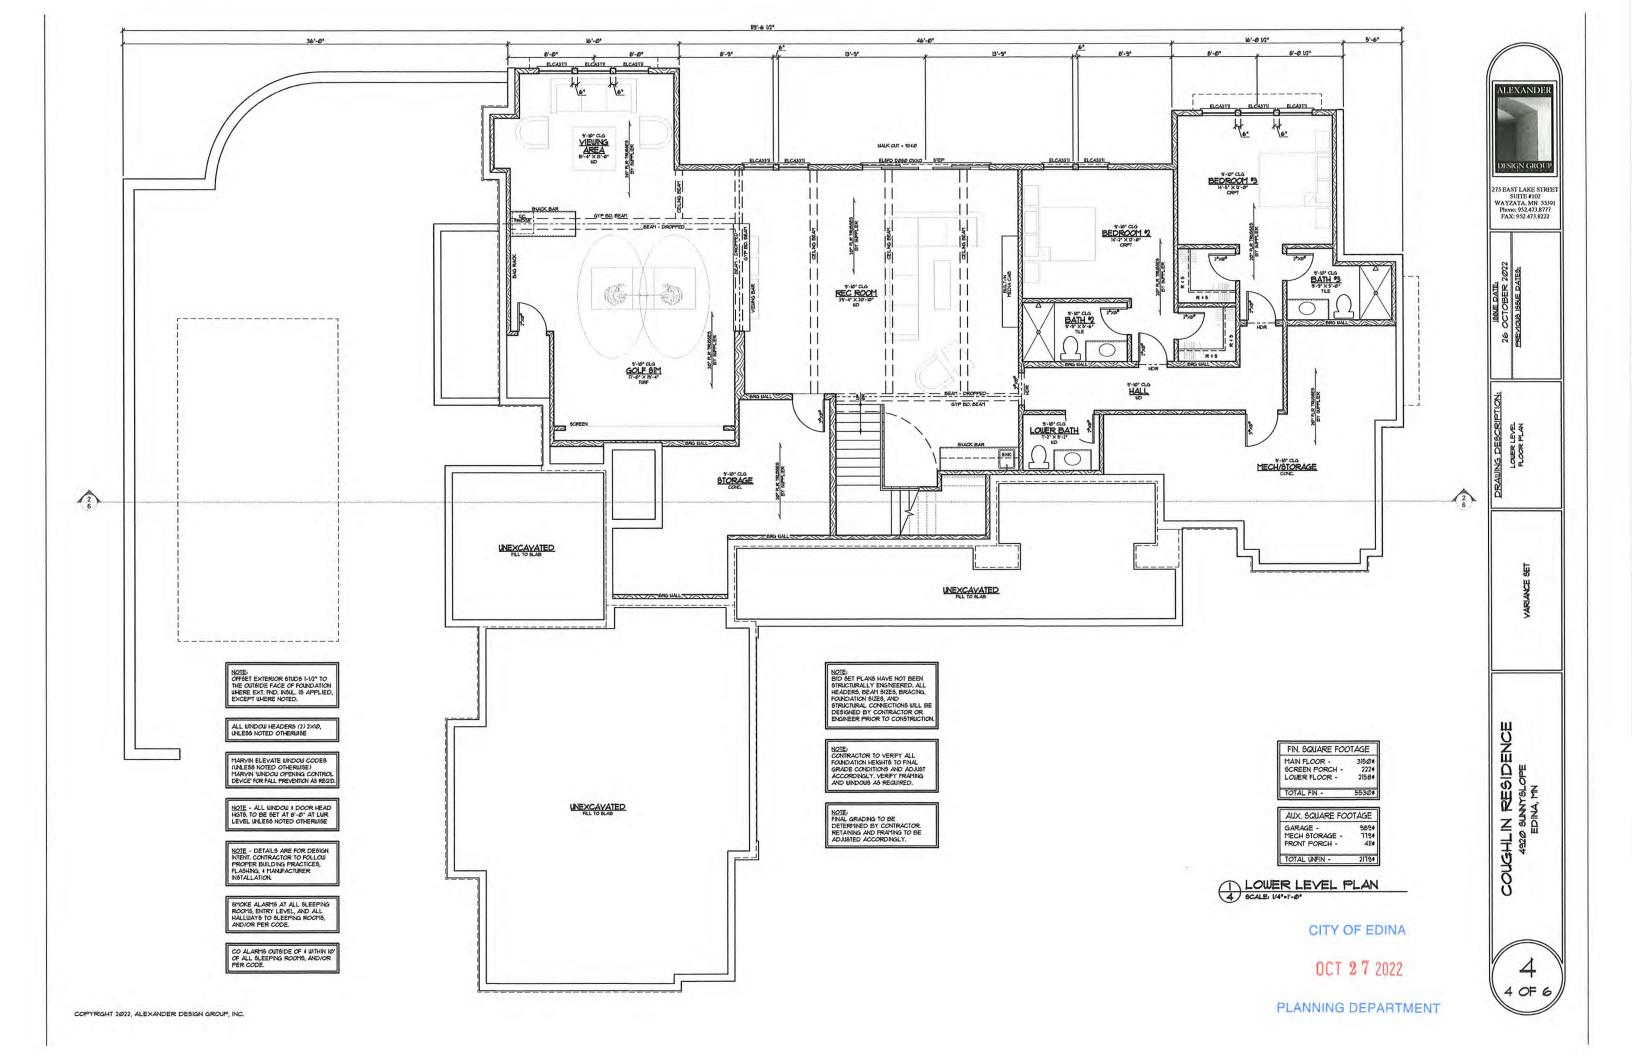

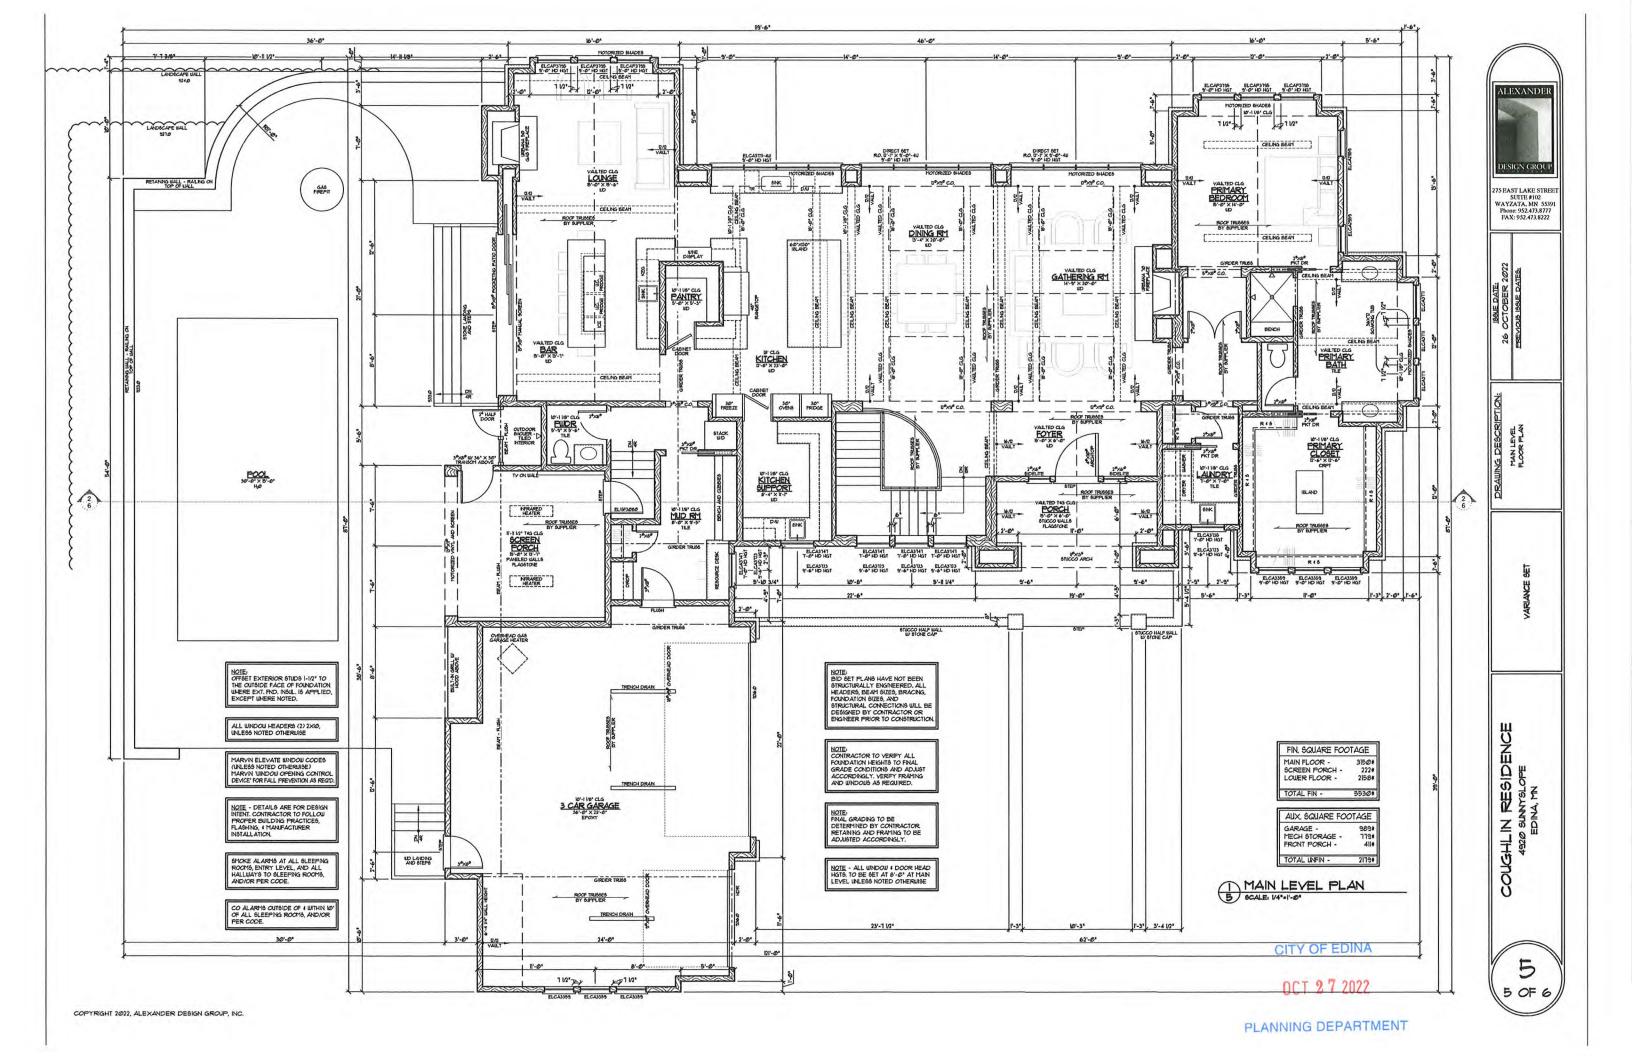

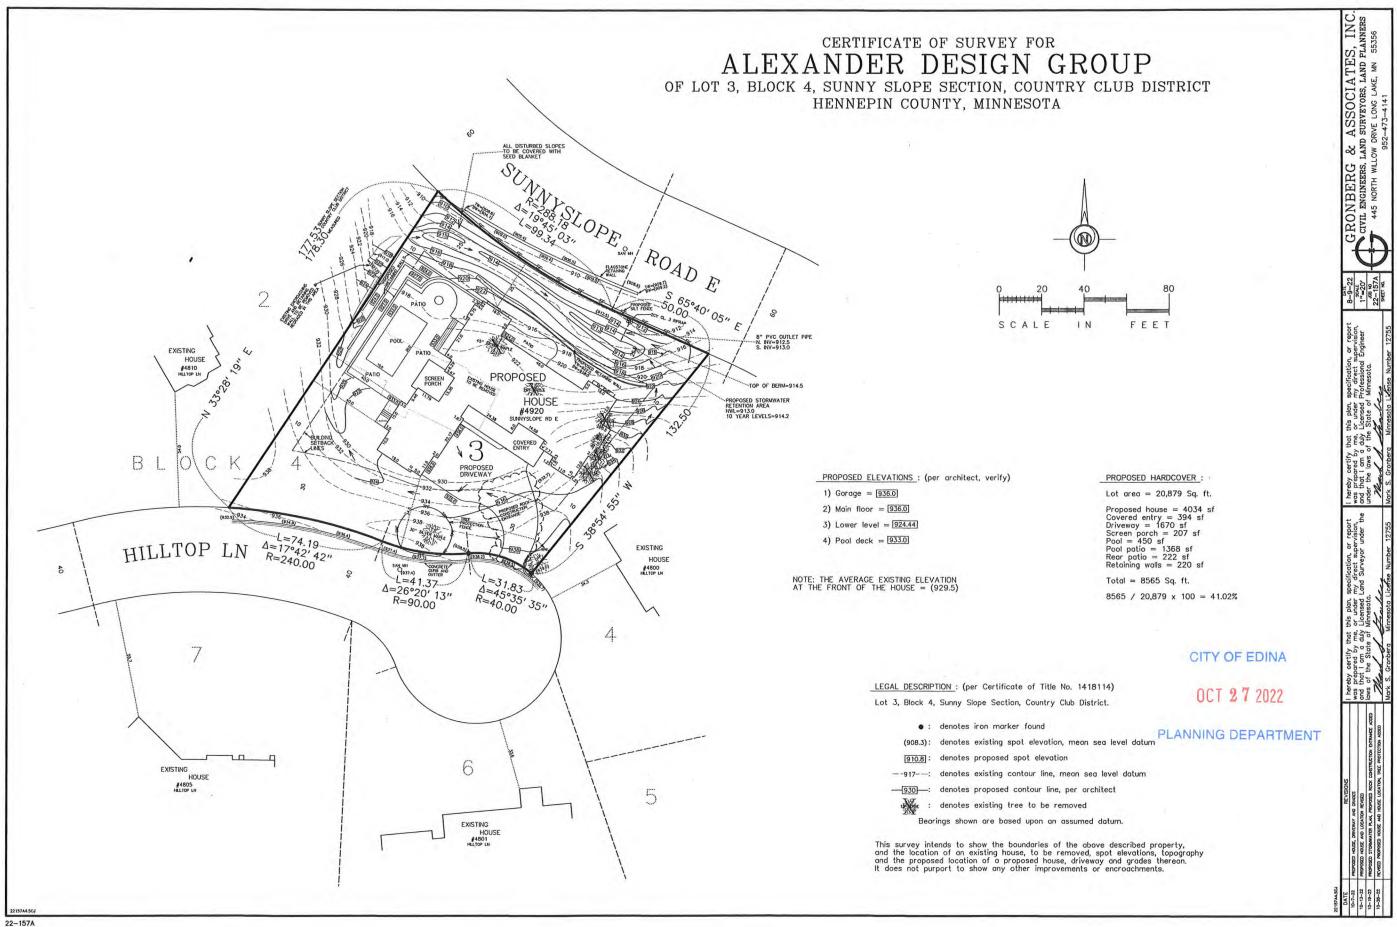


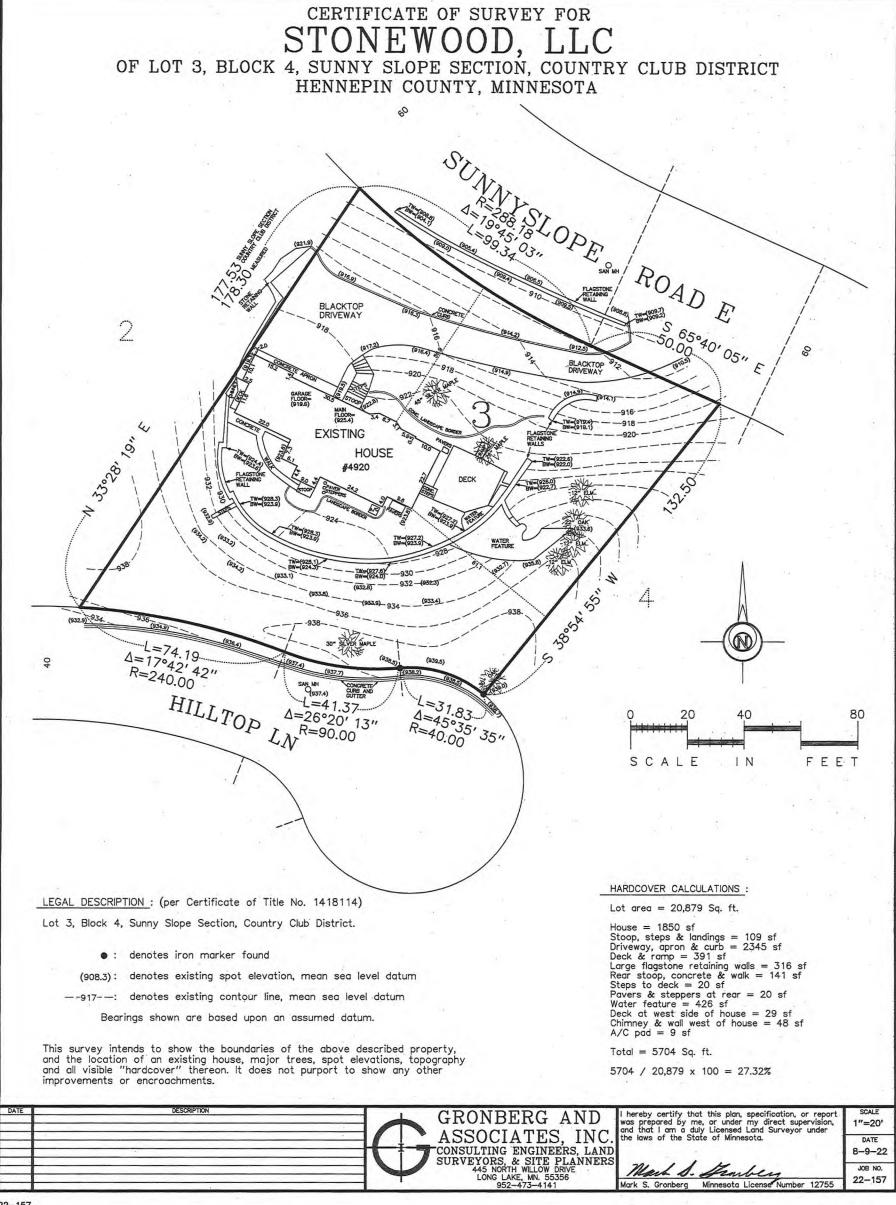



#### 4810 Hilltop

## 4920 Sunnyslope Road - Neighboring Properties

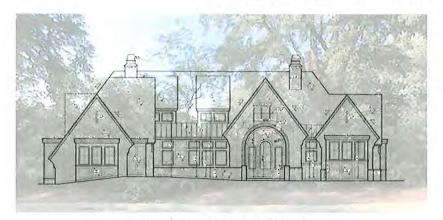


Proposed Home (4920 Sunnyslope Rd)



4800 Hilltop

CITY OF EDINA

OCT 27 2022

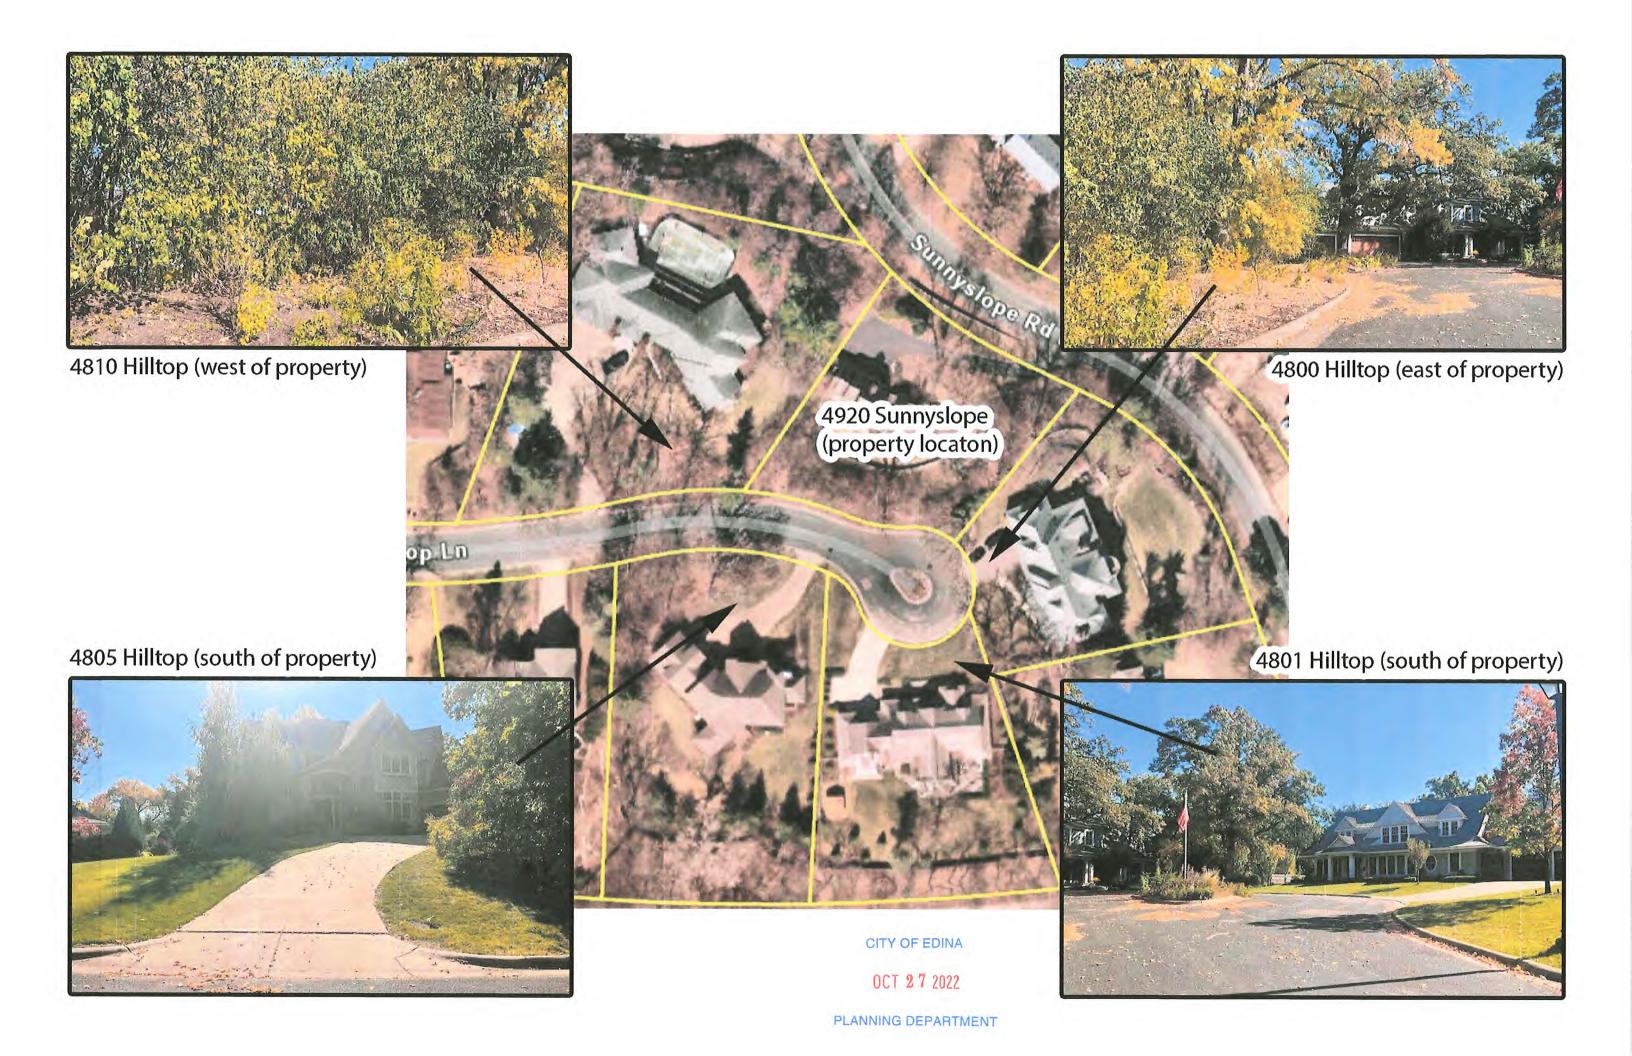

## ALEXANDER DESIGN GROUP 4920 SUNNYSLOPE ROAD, E., EDINA

#### DRAINAGE SUMMARY

October 19, 2022

#### **EXISTING CONDITIONS**

Runoff area = 21,300± SF

Runoff CN no. = 79 for 5704 SF of existing hardcover

Time of conc. = 7 minutes

Q10 = 1.89 CFS using Atlas 14 10 year rainfall

#### PROPOSED CONDITIONS

Runoff area =  $21,300 \pm SF$ 

Runoff CN no. = 82 for 8576 SF of proposed hardcover

Time of conc. = 7 minutes

Q10 = 2.09 CFS

Q10 = 1.58 CFS after ponding which is less then existing

Outlet = 8" PVC culvert, inv. 913.0', 10 year elev. = 914.22'

Top of berm = 914.5

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OCT 2 0 2022


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GRONBERG & ASSOCIATES. INC. 445 N. WILLOW DR. LONG LAKE, MN 55356

I hereby certify that this plan, specification, or report was prepared by me, or under my direct supervision, and that I am a duly Licensed Professional Engineer under the laws of the State of Minnesota.

Mark S. Gronberg

Minnesota License Number 12755

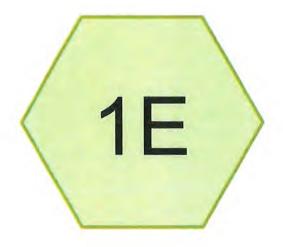

# Area 1 exist

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OCT 2 0 2022

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#### **Project Notes**

Rainfall events imported from "Pioneer Highlands 1st 100 year prop. 7-2-22.hcp"

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Alexander Design Existing 10-19-22
Prepared by HP Inc.
HydroCAD® 10.00-25 s/n 04529 © 2019 HydroCAD Software Solutions LLC

Printed 10/19/2022 Page 3

### Area Listing (all nodes)

Area	CN	Description
(acres)		(subcatchment-numbers)
0.131	98	Existing Hardcover (1E)
0.358	72	Woods/grass comb., Good, HSG C (1E)
0.489	79	TOTAL AREA

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OCT 2 0 2022

## Alexander Design Existing 10-19-22

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### Soil Listing (all nodes)

Area	Soil Group	Subcatchment Numbers
(acres)	Group	Numbers
0.000	HSG A	
0.000	HSG B	
0.358	HSG C	1E
0.000	HSG D	
0.131	Other	1E
0.489		<b>TOTAL AREA</b>

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### **Ground Covers (all nodes)**

HSG-A (acres)	HSG-B (acres)	HSG-C (acres)	HSG-D (acres)	Other (acres)	Total (acres)	Ground Cover	Subcatchment Numbers
0.000	0.000	0.000	0.000	0.131	0.131	Existing Hardcover	1E
0.000	0.000	0.358	0.000	0.000	0.358	Woods/grass comb., Good	1E
0.000	0.000	0.358	0.000	0.131	0.489	TOTAL AREA	

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Alexander Design Existing 10-19-22

MSE 24-hr 3 10-Year Rainfall=4.26" Printed 10/19/2022

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Time span=1.00-36.00 hrs, dt=0.02 hrs, 1751 points
Runoff by SCS TR-20 method, UH=SCS, Weighted-CN
Reach routing by Stor-Ind+Trans method - Pond routing by Stor-Ind method

Subcatchment 1E: Area 1 exist

Runoff Area=21,300 sf 26.78% Impervious Runoff Depth=2.18" Tc=7.0 min CN=79 Runoff=1.89 cfs 0.089 af

Total Runoff Area = 0.489 ac Runoff Volume = 0.089 af Average Runoff Depth = 2.18" 73.22% Pervious = 0.358 ac 26.78% Impervious = 0.131 ac

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### Summary for Subcatchment 1E: Area 1 exist

Runoff


1.89 cfs @ 12.14 hrs, Volume=

0.089 af, Depth= 2.18"

Runoff by SCS TR-20 method, UH=SCS, Weighted-CN, Time Span= 1.00-36.00 hrs, dt= 0.02 hrs MSE 24-hr 3 10-Year Rainfall=4.26"

1	Α	rea (sf)	CN	Description			
*	6	5,704		Existing Ha		2	
-		15,596	72	vvoods/gra	ss comb., C	Good, HSG C	
		21,300	79	Weighted A	verage		
		15,596		73.22% Pe	rvious Area		
		5,704		26.78% lm	pervious Ar	ea	
	Tc (min)	Length (feet)	Slope (ft/ft)		Capacity (cfs)	Description	
1	7.0					Direct Entry,	

### Subcatchment 1E: Area 1 exist

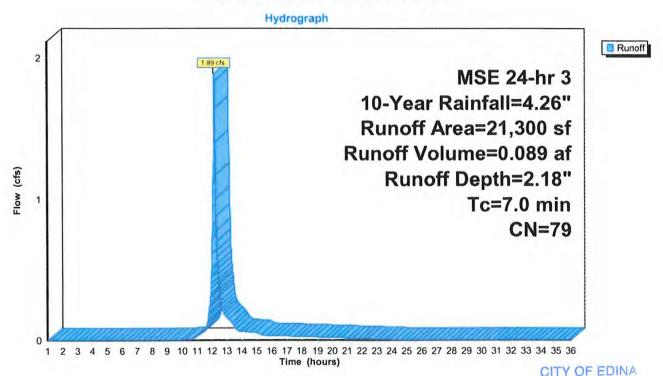

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# Area 1 Proposed Pond



Area 1 proposed

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OCT 20 2022

PLANNING DEPARTMENT









Routing Diagram for Alexander Design proposed 10-19-22
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Alexander Design proposed 10-19-22

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### **Project Notes**

Rainfall events imported from "Alexander Design Existing 10-19-22.hcp"

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### Area Listing (all nodes)

Area (acres)	CN	Description (subcatchment-numbers)
0.197	98	Proposed Hardcover (1P)
0.292	72	Woods/grass comb., Good, HSG C (1P)
0.489	82	TOTAL AREA

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### Soil Listing (all nodes)

Area (acres)	Soil Group	Subcatchment Numbers
0.000	HSG A	
0.000	HSG B	
0.292	HSG C	1P
0.000	HSG D	
0.197	Other	1P
0.489		<b>TOTAL AREA</b>

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### Ground Covers (all nodes)

HSG-A (acres)	HSG-B (acres)	HSG-C (acres)	HSG-D (acres)	Other (acres)	Total (acres)	Ground Cover	Subcatchmen Numbers
0.000	0.000	0.000	0.000	0.197	0.197	Proposed Hardcover	1P
0.000	0.000	0.292	0.000	0.000	0.292	Woods/grass comb., Good	1P
0.000	0.000	0.292	0.000	0.197	0.489	TOTAL AREA	

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### Pipe Listing (all nodes)

Line#	Node Number	In-Invert (feet)	Out-Invert (feet)	Length (feet)	Slope (ft/ft)	n	Diam/Width (inches)		Inside-Fill (inches)
1	1PP	913.00	912.50	10.0	0.0500	0.010	8.0	0.0	0.0

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### Alexander Design proposed 10-19-22

MSE 24-hr 3 10-Year Rainfall=4.26" Printed 10/19/2022

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Time span=1.00-36.00 hrs, dt=0.02 hrs, 1751 points
Runoff by SCS TR-20 method, UH=SCS, Weighted-CN
Reach routing by Stor-Ind+Trans method - Pond routing by Stor-Ind method

Subcatchment 1P: Area 1 proposed

Runoff Area=21,300 sf 40.26% Impervious Runoff Depth=2.43" Tc=7.0 min CN=82 Runoff=2.09 cfs 0.099 af

Pond 1PP: Area 1 Proposed Pond Peak Elev=914.22' Storage=364 cf Inflow=2.09 cfs 0.099 af 8.0" Round Culvert n=0.010 L=10.0' S=0.0500 '/' Outflow=1.58 cfs 0.099 af

Total Runoff Area = 0.489 ac Runoff Volume = 0.099 af Average Runoff Depth = 2.43" 59.74% Pervious = 0.292 ac 40.26% Impervious = 0.197 ac

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### Summary for Subcatchment 1P: Area 1 proposed

Runoff


2.09 cfs @ 12.14 hrs, Volume=

0.099 af, Depth= 2.43"

Runoff by SCS TR-20 method, UH=SCS, Weighted-CN, Time Span= 1.00-36.00 hrs, dt= 0.02 hrs MSE 24-hr 3 10-Year Rainfall=4.26"

	Α	rea (sf)	CN	Description							
*		8,576	98	Proposed Hardcover							
		12,724	72	Woods/gras	ss comb., C	Good, HSG C					
		21,300 12,724 8,576	82	Weighted A 59.74% Per 40.26% Imp	rvious Area						
	Tc (min)	Length (feet)	Slope (ft/ft	The state of the s	Capacity (cfs)	Description					
	7.0					Direct Entry.					

### Subcatchment 1P: Area 1 proposed

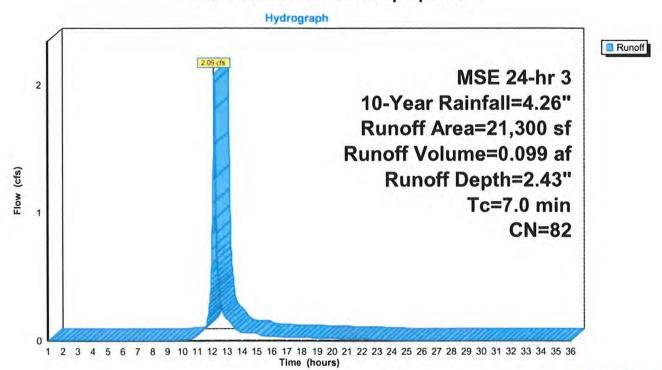

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### Alexander Design proposed 10-19-22

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MSE 24-hr 3 10-Year Rainfall=4.26" Printed 10/19/2022

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### Summary for Pond 1PP: Area 1 Proposed Pond

Inflow Area = 0.489 ac, 40.26% Impervious, Inflow Depth = 2.43" for 10-Year event

Inflow = 2.09 cfs @ 12.14 hrs, Volume= 0.099 af

Outflow = 1.58 cfs @ 12.20 hrs, Volume= 0.099 af, Atten= 24%, Lag= 3.3 min

Primary = 1.58 cfs @ 12.20 hrs, Volume= 0.099 af

Routing by Stor-Ind method, Time Span= 1.00-36.00 hrs, dt= 0.02 hrs Peak Elev= 914.22' @ 12.20 hrs Surf.Area= 521 sf Storage= 364 cf

Plug-Flow detention time= 3.7 min calculated for 0.099 af (100% of inflow)

Center-of-Mass det. time= 3.8 min (805.1 - 801.3)

Volume	In	vert Avail.	Storage	Storage	Description	
#1	913	00'	528 cf	Custon	n Stage Data (Pris	smatic) Listed below (Recalc)
Elevation (fee	70.1	Surf.Area (sq-ft)		c.Store ic-feet)	Cum.Store (cubic-feet)	
913.0 914.0	00	100 420		0 260	0 260	
914.	50	650		268	528	
Device	Routing	Inv	ert Out	let Device	es	
#1	Primary	913.	Inle	t / Outlet		Ke= 0.500 912.50' S= 0.0500 '/' Cc= 0.900 r, Flow Area= 0.35 sf

Primary OutFlow Max=1.58 cfs @ 12.20 hrs HW=914.22' (Free Discharge) 1=Culvert (Inlet Controls 1.58 cfs @ 4.53 fps)

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OCT 2 0 2022


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### Pond 1PP: Area 1 Proposed Pond



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OCT 2 0 2022

# Survey Responses

# **Public Hearing Comments**
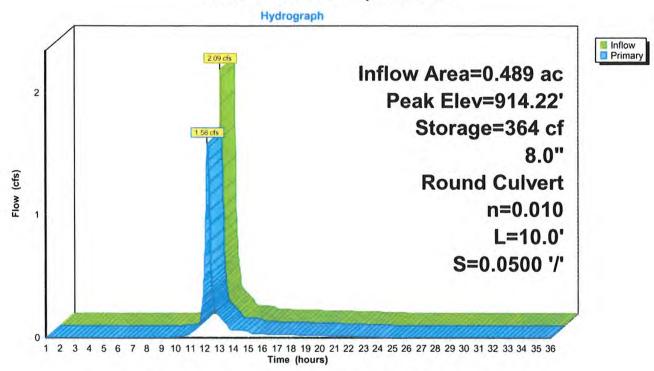
# Better Together Edina

Project: Public Hearing: 4920 Sunnyslope Rd. E



VISITORS  3									
С	ONTRIBUTOR $3$	S		RESPONSES 3					
O O Registered Unverified		O Anonymous	<b>O</b> Registered	<b>O</b> Unverified	<b>O</b> Anonymous				

From: Better Together Edina <notifications@engagementhq.com>

Sent: Thursday, November 10, 2022 8:32 AM

**To:** Emily Bodeker; Kris Aaker; Liz Olson; Cary Teague

**Subject:** Liz Olson completed Public Hearing Comments-4920 Sunnyslope Rd

**EXTERNAL EMAIL ALERT:** This email originated from outside the City of Edina. Do not click links or open attachments unless you recognize the sender and know the content is safe.

Liz Olson just submitted the survey Public Hearing Comments-4920 Sunnyslope Rd with the responses below.

### First and Last Name

Matt Graczyk

### **Address**

4810 Hilltop Lane

### Comment

I'm calling in to strongly oppose the request for a yard setback variance and the 9 foot 6 inch first floor height variance orientation of the house at 4905 Sunnyslope to Hilltop Lane. I live next door and the topography of that lot does not support, in any way shape or form, re-orientation of the house from Sunnyslope to Hilltop Lane. The setback variance would strongly change the character of the neighborhood and the traffic flow on Hilltop Lane which is already been affected by a previous granting of a house re-orientation to Hilltop. I'm asking the Planning Commission to strongly oppose this and deny the request for both setback variance and re-rotation of home. Thank you very much very my comment so follow-up with the online form and plan to attend the upcoming Planning Commission meeting next week. Thank you very much for the consideration. (Voicemail was received 11/10/22 at 5:33 AM. Transcribed by Liz Olson, Planning Admin)

If this is a test response, click <u>here</u> to discard it.

(The discard option is available only for admin)

**From:** Better Together Edina <notifications@engagementhg.com>

Sent: Thursday, November 10, 2022 9:32 AM

**To:** Emily Bodeker; Kris Aaker; Liz Olson; Cary Teague

**Subject:** Anonymous User completed Public Hearing Comments-4920 Sunnyslope Rd

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Anonymous User just submitted the survey Public Hearing Comments-4920 Sunnyslope Rd with the responses below.

### **First and Last Name**

Katie Graczyk

### **Address**

4810 Hilltop Lane

### Comment

Strongly oppose BOTH variance requests. The setback request is too close to the street. MORE than 10 foot difference between request and average for existing home on the block. The topography of the lot does NOT support a height variance and the home should NOT be re oriented to Hilltop Lane. The traffic on this cul-de-sac street is already at capacity.

From: Better Together Edina <notifications@engagementhq.com>

Sent: Thursday, November 10, 2022 10:18 AM

**To:** Emily Bodeker; Kris Aaker; Liz Olson; Cary Teague

**Subject:** Anonymous User completed Public Hearing Comments-4920 Sunnyslope Rd

**EXTERNAL EMAIL ALERT:** This email originated from outside the City of Edina. Do not click links or open attachments unless you recognize the sender and know the content is safe.

Anonymous User just submitted the survey Public Hearing Comments-4920 Sunnyslope Rd with the responses below.

### First and Last Name

Matt Graczyk

### **Address**

4810 Hilltop Lane

### Comment

I strongly oppose the variances proposed for the following reasons: 1)The setback request is too close to the street. A 10 foot difference from average of surrounding properties negatively impacts site lines from the street and adjacent homes. 2)The topography of the lot does not support a height variance. There is adequate building envelope under current rules, regulations and orientation. The lot does not support a home facing Hilltop Lane. Approving a height variance negatively impacts the aesthetics and site lines of the entire street. 3)We don't need more traffic on a small culde-sac with limited room for on street parking and passing traffic. I kindly ask the planning commission to reject the proposal. Regards,, Matt Graczyk

**From:** Better Together Edina <notifications@engagementhg.com>

Sent: Monday, November 14, 2022 4:08 PM

**To:** Emily Bodeker; Kris Aaker; Liz Olson; Cary Teague

**Subject:** Liz Olson completed Public Hearing Comments-4920 Sunnyslope Rd

**EXTERNAL EMAIL ALERT:** This email originated from outside the City of Edina. Do not click links or open attachments unless you recognize the sender and know the content is safe.

Liz Olson just submitted the survey Public Hearing Comments-4920 Sunnyslope Rd with the responses below.

### First and Last Name

Katie Graczyk

### **Address**

4801 Hilltop Lane

### Comment

I wanted to share that we strongly oppose the request for the 2 variances. First, the setback request is too close to the street and it's over 10 feet difference from the average of the surrounding homes and so we'll have a significant impact on the sight lines from the street and the adjacent homes. The other variance request that we propose is the topography of the lot does not support a height variance. There is adequate building envelope under the current rules, regulations, and orientation and that the lot does not support a home facing Hilltop Lane. Approving a height variance negatively impacts the aesthetics and sight lines of the entire street. The third reason we oppose both variances is that we don't need more traffic on the small cul-de-sac street. So if you could make sure those comments are added to the record that would be great. Thanks. (Voicemail received at 9:34 AM on November 10, 2022. Transcribed by Planning Staff)


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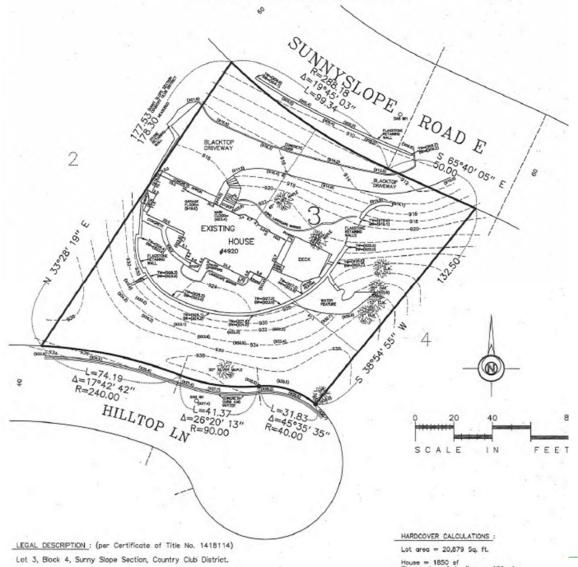


# Setback and Ist floor height variance request

For a new home facing Hilltop Lane at 4920 Sunnyslope E






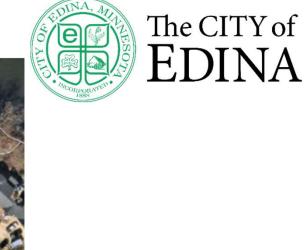







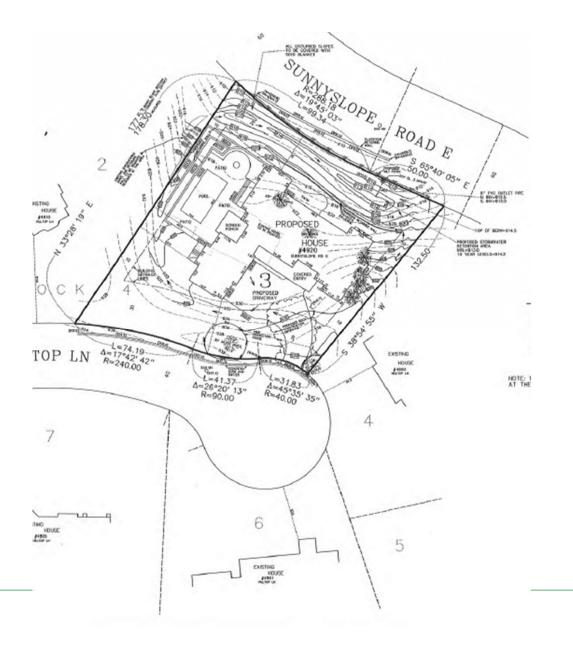











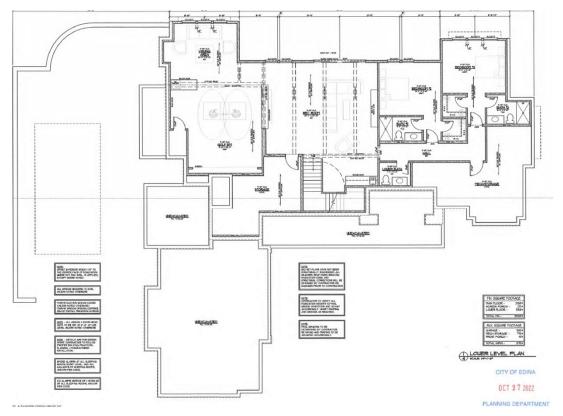



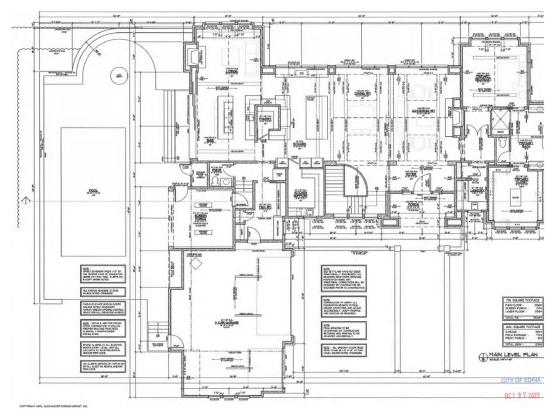











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### 4920 Sunnyslope Road - Neighboring Properties







4800 Hilltop

