GENERAL NOTES

- LANDSCAPE CONTRACTOR SHALL INSPECT THE SITE AND BECOME FAMILIAR WITH EXISTING CONDITIONS RELATING TO THE NATURE AND SCOPE OF WORK.
- LANDSCAPE CONTRACTOR SHALL VERIFY PLAN LAYOUT AND DIMENSIONS SHOWN AND BRING TO THE ATTENTION OF THE LANDSCAPE ARCHITECT DISCREPANCIES WHICH MAY COMPROMISE THE DESIGN AND/OR INTENT OF THE PROJECT'S LAYOUT.
- LANDSCAPE CONTRACTOR SHALL ASSURE COMPLIANCE WITH APPLICABLE CODES AND REGULATIONS GOVERNING THE WORK AND/OR MATERIALS SUPPLIED.
- LANDSCAPE CONTRACTOR SHALL PROTECT EXISTING ROADS, CURBS/GUTTERS, TRAILS, TREES, LAWNS AND SITE ELEMENTS DURING CONSTRUCTION OPERATIONS. DAMAGE TO SAME SHALL BE REPAIRED AT NO ADDITIONAL COST TO THE OWNER.
- LANDSCAPE CONTRACTOR SHALL VERIFY ALIGNMENT AND LOCATION OF UNDERGROUND AND ABOVE GRADE UTILITIES AND PROVIDE THE NECESSARY PROTECTION FOR SAME BEFORE CONSTRUCTION / MATERIAL INSTALLATION BEGINS (MINIMUM 10'-0" CLEARANCE).
- UNDERGROUND UTILITIES SHALL BE INSTALLED SO THAT TRENCHES DO NOT CUT THROUGH ROOT SYSTEMS OF ANY EXISTING TREES TO REMAIN.
- EXISTING CONTOURS, TRAILS, VEGETATION, CURB/GUTTER AND OTHER ELEMENTS ARE BASED UPON INFORMATION SUPPLIED TO THE LANDSCAPE ARCHITECT BY OTHERS. LANDSCAPE CONTRACTOR SHALL VERIFY DISCREPANCIES PRIOR TO CONSTRUCTION AND NOTIFY LANDSCAPE ARCHITECT OF SAME.
- ALIGNMENT AND GRADES OF THE PROPOSED WALKS, TRAILS AND/OR ROADWAYS ARE SUBJECT TO FIELD ADJUSTMENT REQUIRED TO CONFORM TO LOCALIZED TOPOGRAPHIC CONDITIONS AND TO MINIMIZE TREE REMOVAL AND GRADING. CHANGES IN THE ALIGNMENT AND GRADES MUST BE APPROVED BY THE LANDSCAPE ARCHITECT.
- LANDSCAPE CONTRACTOR SHALL REVIEW THE SITE FOR DEFICIENCIES IN THE PLANT MATERIAL SELECTIONS AND OTHER SITE CONDITIONS WHICH MIGHT NEGATIVELY AFFECT PLANT ESTABLISHMENT, SURVIVAL OR WARRANTY. UNDESIRABLE PLANT MATERIAL SELECTIONS OR SITE CONDITIONS SHALL BE BROUGHT TO THE ATTENTION OF THE LANDSCAPE ARCHITECT PRIOR TO BEGINNING OF WORK.
- 10. LANDSCAPE CONTRACTOR SHALL PREPARE AND SUBMIT REPRODUCIBLE AS-BUILT DRAWING(S) OF LANDSCAPE INSTALLATION, IRRIGATION AND SITE IMPROVEMENTS UPON COMPLETION OF
- 11. NO PLANTS WILL BE INSTALLED UNTIL FINAL GRADING AND CONSTRUCTION HAS BEEN COMPLETED IN THE IMMEDIATE AREA.
- 12. SOD AREAS DISTURBED DUE TO GRADING SHALL BE REPLACED, UNLESS NOTED OTHERWISE.
- 13. WHERE SOD ABUTS PAVED SURFACES, FINISHED GRADE OF SOD/SEED SHALL BE HELD 1"
- BELOW SURFACE ELEVATION OF TRAIL, SLAB, CURB, ETC. 14. SOD SHALL BE LAID PARALLEL TO THE CONTOURS AND SHALL HAVE STAGGERED JOINTS. ON
- SLOPES STEEPER THAN 3:1 OR IN DRAINAGE SWALES, SOD SHALL BE STAKED SECURELY. 15. PROPOSED PLANT MATERIAL SHALL COMPLY WITH THE LATEST EDITION OF THE AMERICAN STANDARD FOR NURSERY STOCK, ANSI Z60.1. UNLESS NOTED OTHERWISE, DECIDUOUS SHRUBS SHALL HAVE AT LEAST 5 CANES AT THE SPECIFIED HEIGHT. ORNAMENTAL TREES SHALL HAVE NO 'V' CROTCHES AND SHALL BEGIN BRANCHING NO LOWER THAN 3' FEET ABOVE
- LANDSCAPE CONTRACTOR SHALL ASSURE COMPLIANCE WITH APPLICABLE CODES AND REGULATIONS GOVERNING THE WORK AND/OR MATERIALS SUPPLIED.
- 17. LANDSCAPE CONTRACTOR IS RESPONSIBLE FOR ONGOING MAINTENANCE OF NEWLY INSTALLED MATERIALS UNTIL TIME OF OWNER ACCEPTANCE. ACTS OF VANDALISM OR DAMAGE WHICH MAY OCCUR PRIOR TO OWNER ACCEPTANCE SHALL BE THE RESPONSIBILITY OF THE LANDSCAPE CONTRACTOR.
- 18. LANDSCAPE CONTRACTOR SHALL WARRANTY NEW PLANT MATERIAL THROUGH ONE CALENDAR YEAR FROM THE DATE OF THE OWNER ACCEPTANCE. NO PARTIAL ACCEPTANCE WILL BE
- 19. PLANTING AREAS (NOT OVER STRUCTURE) RECEIVING GROUND COVER, PERENNIALS, ANNUALS, AND/OR VINES SHALL RECEIVE A MINIMUM OF 18" DEPTH OF PLANTING SOIL CONSISTING OF AT LEAST 45 PARTS TOPSOIL, 45 PARTS SCREENED COMPOST OR MANURE AND 10 PARTS SAND.
- 20. ANNUAL AND PERENNIAL PLANTING BEDS TO RECEIVE 4" DEEP SHREDDED HARDWOOD MULCH WITH NO WEED BARRIER.
- 21. SHRUB BED MASSINGS TO RECEIVE 4" DEEP SHREDDED HARDWOOD MULCH WITH FIBER MAT
- STEEL EDGER TO BE USED TO CONTAIN SHRUBS, PERENNIALS AND ANNUALS WHERE PLANTING BED MEETS SOD UNLESS OTHERWISE NOTED.
- 23. REFER TO CIVIL FOR SITE DEMOLITION INFORMATION.
- 24. REFER TO CIVIL FOR ADDITIONAL SITE GRADING AND UTILITY INFORMATION
- 25. IF A DISCREPANCY EXISTS BETWEEN THE NUMBER OF PLANTS SHOWN IN THE PLANT MATERIALS SCHEDULE AND THE PLANS, THE PLANS SHALL GOVERN.
- 26. CONTRACTOR SHALL STAKE OUT LOCATION OF ALL PROPOSED TREES FOR APPROVAL BY LANDSCAPE ARCHITECT PRIOR TO INSTALLATION. IRRIGATION NOTES
- LANDSCAPE CONTRACTOR SHALL BE RESPONSIBLE FOR PROVIDING A PERFORMANCE IRRIGATION PLAN AND SPECIFICATIONS AS PART OF THE SCOPE OF WORK WHEN BIDDING. THESE SHALL BE APPROVED BY THE LANDSCAPE ARCHITECT PRIOR TO ORDER AND/OR INSTALLATION. IT SHALL BE THE LANDSCAPE CONTRACTOR'S RESPONSIBILITY TO INSURE THAT SODDED/SEEDED AND PLANTED AREAS ARE IRRIGATED PROPERLY, INCLUDING THOSE AREAS DIRECTLY AROUND AND ABUTTING BUILDING FOUNDATION.
- SHRUB & PERENNIAL BEDS TO BE IRRIGATED WITH DRIP IRRIGATION. SOD TO BE IRRIGATED
- LANDSCAPE CONTRACTOR SHALL PROVIDE THE OWNER WITH A WATERING/LAWN IRRIGATION SCHEDULE APPROPRIATE TO THE PROJECT SITE CONDITIONS AND TO PLANT MATERIALS GROWTH REQUIREMENTS.
- LANDSCAPE CONTRACTOR SHALL INSURE THAT SOIL CONDITIONS AND COMPACTION ARE ADEQUATE TO ALLOW FOR PROPER DRAINAGE AROUND THE CONSTRUCTION SITE. UNDESIRABLE CONDITIONS SHALL BE BROUGHT TO THE ATTENTION OF THE LANDSCAPE ARCHITECT PRIOR TO BEGINNING OF WORK. IT SHALL BE THE LANDSCAPE CONTRACTOR'S RESPONSIBILITY TO INSURE PROPER SURFACE AND SUBSURFACE DRAINAGE IN ALL PLANTING
- 5. COORDINATE IRRIGATION SLEEVING LOCATIONS WITH GENERAL CONTRACTOR.
- 6. RAIN SENSORS TO BE INCLUDED WITHIN THE IRRIGATION DESIGN.
- 7. IRRIGATION LIMITS TO EXTEND TO STREET BACK OF CURB.

SURVEY NOTES

- 1. ALL EXISTING CONDITIONS SHOWN ON THIS DRAWING ARE BASED ON AN OWNER-FURNISHED SURVEY. BKV GROUP OFFERS NO GUARANTEE, EITHER EXPRESSED OR IMPLIED, FOR THE ACCURACY OR RELIABILITY OF THE INDICATED EXISTING CONDITIONS.
- THE CONTRACTOR SHALL FIELD VERIFY ALL CRITICAL EXISTING CONDITIONS INCLUDING, BUT NOT LIMITED TO, EXISTING BUILDING LOCATIONS, UTILITY LOCATIONS AND INVERT ELEVATIONS,
- AND EXISTING SITE GRADES PRIOR TO THE START OF WORK. ANY OBSERVED DEVIATIONS FROM CONDITIONS INDICATED ON THE DRAWINGS SHALL BE BROUGHT TO THE ARCHITECT OR LANDSCAPE ARCHITECT'S ATTENTION IMMEDIATELY UPON

SITE PLAN NOTES

- NO BUILDING SIGNAGE PROPOSED AT THIS TIME.
- TRASH/RECYCLING WILL BE COLLECTED WITHIN THE BUILDING AT GROUND LEVEL. COLLECTION WILL OCCUR ON-SITE WITHIN ENCLOSED LOADING AREAS BY PRIVATE VENDORS.
- SNOW WILL BE REMOVED FROM SIDEWALKS. A LIMITED AMOUNT OF SNOW STORAGE IS AVAILABLE ALONG THE STREET BOULEVARDS.

SHEET INDEX:

SHEET NUMBEF		SSUE 01	021-07-02 SD SET	2021-09-10 DD SET	ISSUE 04	SUE 05	ISSUE 06
INGIVIDEI	OTILLT NAME	<u> </u>	700	Ŋ	<u> </u>	<u>S</u>	<u> </u>
4 0515	TO ALL INICODA A TION						
1 - GENE	ERAL INFORMATION						
	ERAL INFORMATION LANDSCAPE TITLE SHEET		Х	Х	Х		
L001			Х	Х	Х		
L001 3 - STAN	LANDSCAPE TITLE SHEET		X	X	X		
L001 3 - STAN L100	LANDSCAPE TITLE SHEET IDARD SHEETS				1		
L001 3 - STAN L100 L101	LANDSCAPE TITLE SHEET IDARD SHEETS SITE - LANDSCAPE PLAN		X	X	X		
L001	LANDSCAPE TITLE SHEET IDARD SHEETS SITE - LANDSCAPE PLAN SITE - PLANTING PLAN		X	X	X	X	

Architecture Interior Design Landscape Architecture Engineering

222 North Second Street

Long & Kees Bldg Minneapolis, MN

www.bkvgroup.com

CONSULTANTS

PROJECT TITLE

4917 EDEN AVE

10/05/2021 FINAL DEVELOPMENT SET

CERTIFICATION

CHECKED BY COMMISSION NUMBER 2286-05 SHEET TITLE

> LANDSCAPE TITLE SHEET

SHEET NUMBER

© 2019 BKV Group



Architecture Interior Design Landscape Architecture Engineering

222 North Second Street

Long & Kees Bldg Suite 101 Minneapolis, MN 612.339.3752

www.bkvgroup.com

CONSULTANTS

PROJECT TITLE

4917 EDEN AVE


KEY NOTES:

- PROPERTY LINE
- CONCRETE CURB AND GUTTER; SEE CIVIL FOR EXTERIOR ALIGNMENTS L3 C.I.P. PLAIN CONCRETE WALK; SEE CIVIL

AND BOTTOM WALL ELEVATIONS, SEE X/L3XX


- C.I.P. COLORED CONCRETE (A), CEMSTONE 'HARBOR MIST' CPC 120-L'; JOINTING PER PLAN, 3/8" SAWN JOINTS, SEE SPEC.
- C.I.P.PLAIN CONCRETE EXTERIOR STAIR; SEE STRUCTURAL FOR REINFORCING, SEE ARCH. FOR RAILING, FINISH TO MATCH UNIT BALCONIES
- L9 PRIVATE PATIO, C.I.P. PLAIN CONC., SEE ARCH. FOR STOOP CONNECTION L10 SEGMENTAL BLOCK RETAINING WALL, VERSA-LOK PRODUCT TBD, HEIGHT VARIES SEE CIVIL FOR TOP
- L11 DRY STACKED BLOCK PLANTER WALL WITHOUT CAP BLOCK, ROCHESTER CONCRETE
- 'CONTEMPORARY WALL' CASCADE COLOR, 20" FINISHED HEIGHT, SEE X/L3XX L12 DRY STACKED BLOCK RETAINING WALL WITHOUT CAP BLOCK, ROCHESTER CONCRETE
- 'CONTEMPORARY WALL' CASCADE COLOR, HEIGHT VARIES SEE CIVIL FOR TOP AND BOTTOM WALL ELEVATIONS, SEE X/L3XX
- L13 FESTOON LIGHTING, SEE ELEC. FOR PRODUCT, SEE X/L3XX FOR ATTACHEMENTS
- L17 RAISED UNIT DECKS, SEE ARCH. L18 TURF GRASS, SOD, INCLUDING IRRIGATION; SEE SPEC
- L20 PLANTING BED, ROCK MULCH, 3/8" TRAP ROCK, CLEAN, 3" DEPTH, FILTER FABRIC UNDERLAYMENT, PROVIDE AUTOMATED DRIP IRRIGATION AND STEEL LANDSCAPE EDGER; SEE 1 AND 2/L300 SEE 3/L300 FOR STEEL EDGER DETAIL
- L23 DOG RUN AREA, 3/8" PEA GRAVEL CLEAN, 6" MIN. WITH FILTER FABRIC UNDERLAYMENT, SEE X/LXXX L24 DECORATIVE ROCK MULCH SURFACING, 3/8" TRACK ROCK, CLEAN, 3" MIN. DEPTH, FILTER FABRIC
- L25 BENCH (A); 'VILNIUS' BY LANDSCAPE FORMS, BLACK ACID ETCHED FINISH, SURFACE MOUNT PER
- MANUFACT. SPEC(S), (5 TOTAL UNITS) L28 DOGIPOT, DOG WASTE STATION WITH ONE PUL BAG SYSTEM DEPOT-022-B, BLACK FINISH, INSTALLED
- PER MANUFACT. SPEC(S) WITH CONCRETE FOOTING (4 TOTAL UNITS) L29 FREESTANDING FURNISHINGS; FFE BY OWNER
- L33 4' STEEL PICKET DOG RUN FENCE, AMERISTAR 'MONTAGE PLUS MAJESTIC STYLE', BLACK POWDERCOATED FINISH, INSTALLED AT GRADE PER MANUFACT. SPEC(S)
- L37 FREESTANDING PLANTERS (C) WITH SUBSURFACE IRRIGATION CONNECTION; TOURNESOL
- 'BOULEVARD SQUARE', 48"SQ X 35"T, 'WESTERN RED CEDAR' FINISH (4 TOTAL UNITS) L41 QUARRIED GRANITE BOULDER SEATING (A), 24"W X 18"T X 60"L, SAWN TOP AND BOTTOM, SPLIT FACE
- SIDES (2 TOTAL UNITS) SEE X/L3XX L42 QUARRIED GRANITE BOULDER SEATING (A), 24"SQ X 18"T, SAWN TOP AND BOTTOM, SPLIT FACE SIDES (4 TOTAL UNITS) SEE X/L3XX
- L44 SHORTGRASS PRAIRIE SEED MIX, SEED MIX TBD SCULPTURE/ART LOCATIONS, BY OWNER
- ELECTRICAL EQUIPMENT PAD, SEE ELEC. FOR EQUIPMENT
- L48 PARKING GARAGE TRANSITION WELL, SHOWN FOR REFERENCE, SEE ARCH. L52 DECORATIVE METAL SCREEN FENCE, 6' TALL PICKET STYLE WITH PERFORATED METAL BACKING; SEE

GRAPHIC LEGEND:

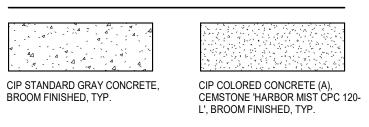






DOG RUN, 3/4" PEA GRAVEL, CLEAN, 6" MIN. DEPTH, TYP.

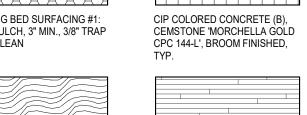



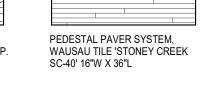

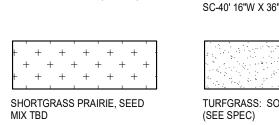

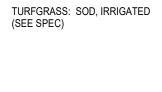

SHEET NUMBER

COMMISSION NUMBER 2286-05

CERTIFICATION

DRAWN BY CHECKED BY

SHEET TITLE

© 2019 BKV Group

TRUE NORTH PLAN NORTH

Architecture Interior Design Landscape Architecture Engineering

222 North Second Street Long & Kees Bldg Suite 101 Minneapolis, MN 55401 612.339.3752

www.bkvgroup.com

CONSULTANTS

PROJECT TITLE

4917 EDEN AVE

PROPOSED PLANT SCHEDULE:

OTV	SYM	COMMON NAME	SCIENTIFIC NAME	PLAN S
		S/VINES/ANNUALS	SCIENTIFIC NAME	
24		1	Colomographia y acutiflora Warl Forestar'	#1 C
	ca	KARL FORESTER GRASS	Calamagrostis x acutiflora 'Karl Forester'	
9 53	hb	BLUE ANGEL HOSTA DESIGNER GENES HOSTA	Hosta 'Blue Angel' Hosta 'Designer Genes'	#1 C
	hd		•	
6 82	hh	HAPPY RETURNS DAYLILY	Hemerocallis 'Happy Returns'	#1 C
34	pt	GREEN CARPET PACHYSANDRA	Pachysandra terminalis 'Green Carpet'	
	sh	PRAIRIE DROPSEED AL TREES	Sporobolus Heterolepis	#1 (
			A maralamakin ya muan didana I Ayakaman Daillian asl	0".4
7	AG	AUTUMN BRILLIANCE SERVICEBERRY	Amelanchir x grandiflora 'Autumn Brilliance'	2"
6	MD	GLADIATOR CRABAPPLE	Malus x adstringens 'Durleo' (PP20,167)	2" (
9	SR	IVORY SILK JAPANESE TREE LILAC	Syringa reticulata 'Ivory Silk'	2" (
		N SHRUBS	Danier VIOLence I	115.6
9	Bg	CHICAGOLAND GREEN BOXWOOD	Buxus X 'Glencoe'	#5 0
26	Jc	SPARTAN JUNIPER	Juniperus chinensis 'Spartan'	6'
18	Jm	MANEY JUNIPER	Juniperus chinensis 'Maneyi'	#5 C
20	То	TECHNITO ARBORVITAE	Thuja occidentalis 'Balijohn'	4' F
DECI		S TREES	T	
7	AS	GREEN MOUNTAIN SUGAR MAPLE	Acer saccharum 'Green Mountain'	2.5"
6	BN	RIVER BIRCH	Betula nigra	2.5"
6	BP	DAKOTA PINNACLE BIRCH	Betula platyphylla 'Fargo'	2.5"
1	GB	AUTUMN GOLD GINKGO	Ginkgo Biloba 'Autumn Gold'	2.5"
8	GT	SKYLINE HONEYLOCUST	Gleditsia triacanthos var. inermis 'Skycole'	2.5"
6	PT	PRAIRIE GOLD ASPEN	Populus tremuloides 'NEArb'	2.5"
8	QA	QUAKING ASPEN	Populous tremuloides	#20
7	QB	SWAMP WHITE OAK	Quercus bicolor	2.5'
5	TA	AMERICAN SENTRY LINDEN	Tilia americana 'MnKSentry'	2.5'
	DUOUS	SHRUBS		
63	Am	LOW SCAPE MOUND CHOKEBERRY	Aronia melanocarpa 'UCONN 165' (PP28, 789)	#2 (
8	Cb	IVORY HALO DOGWOOD	Cornus alba 'Bailhalo'	#5 (
18	Сс	SUGARTINA CLETHRA	Clethra alnifolia 'Crystalina' (PP21, 561)	#2 (
32	Ds	BUTTERFLY BUSH HONEYSUCKLE	Diervilla sessilifolia 'Butterfly'	#5 (
32	Mm	IRIQUOIS BEAUTY BLACK CHOKEBERRY	Aronia melanocarpa 'Morten'	#5 (
24	Ra	ALPINE CURRANT	Ribes alpinum	#5 (
19	Rg	GRO LOW SUMAC	Rhus aromatica 'Gro Low'	#5 (
52	Rn	FLOWER CARPET ROSE	Rosa x 'Noamel'	#1 (
33	Ss	SEM FALSE SPIREA	Sorbaria sorbifolia 'Sem'	#5 (
CONI	FEROL	JS TREES		
12	PA	NORWAY SPRUCE	Picea abies	8'
7	PS	WHITE PINE	Pinus Strobus	6'

GRAPHIC LEGEND:

CIP STANDARD GRAY CONCRETE, BROOM FINISHED, TYP.	CIP COLORED CONCRETE (CEMSTONE 'HARBOR MIST L', BROOM FINISHED, TYP.
PLANTING BED SURFACING #1: ROCK MULCH, 3" MIN., 3/8" TRAP ROCK, CLEAN	CIP COLORED CONCRETE (CEMSTONE 'MORCHELLA G CPC 144-L', BROOM FINISHE TYP.

PLANTING BED SURFACING #2: PEDESTAL PAVER SYSTEM, WAUSAU TILE 'STONEY CREEK SC-40' 16"W X 36"L HARDWOOD MULCH, 4" MIN., TYP.

SHORTGRASS PRAIRIE, SEED MIX TBD

TURFGRASS: SOD, IRRIGATED (SEE SPEC)

TRUE NORTH PLAN NORTH

DOG RUN, 3/4" PEA GRAVEL, CLEAN, 6" MIN. DEPTH, TYP.

SHEET NUMBER

COMMISSION NUMBER 2286-05

CERTIFICATION


CHECKED BY

SHEET TITLE

SITE - PLANTING

PLAN

© 2019 BKV Group

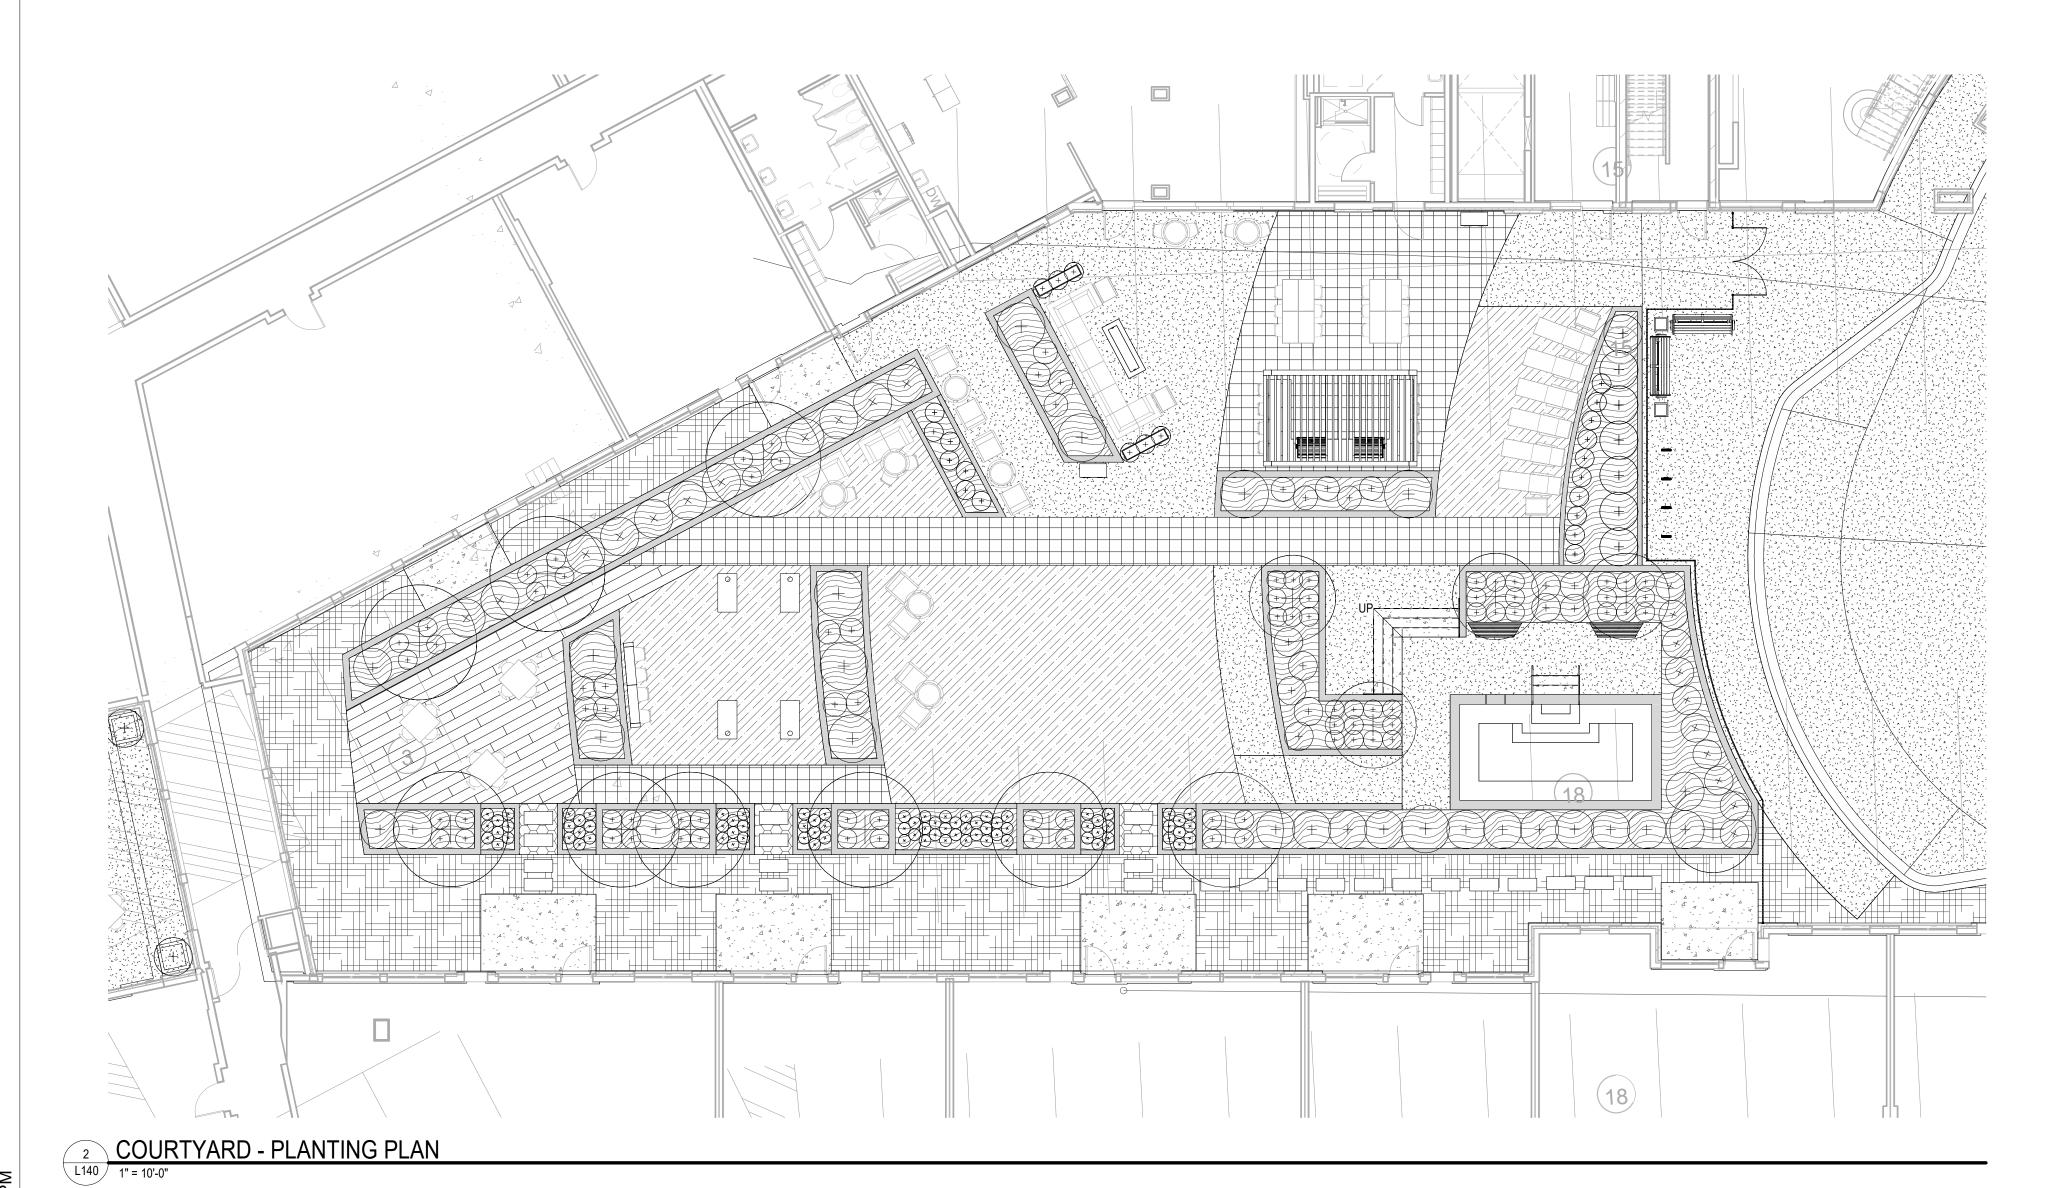

PROPOSED PLANT SCHEDULE:

QTY	SYM	COMMON NAME	SCIENTIFIC NAME	PLA S
PERE	NNIAL	S/VINES/ANNUALS		'
24	ca	KARL FORESTER GRASS	Calamagrostis x acutiflora 'Karl Forester'	#1 (
9	hb	BLUE ANGEL HOSTA	Hosta 'Blue Angel'	#1 (
53	hd	DESIGNER GENES HOSTA	Hosta 'Designer Genes'	#1 (
6	hh	HAPPY RETURNS DAYLILY	Hemerocallis 'Happy Returns'	#1 (
82	pt	GREEN CARPET PACHYSANDRA	Pachysandra terminalis 'Green Carpet'	#1 (
34	sh	PRAIRIE DROPSEED	Sporobolus Heterolepis	#1 (
ORNA	MENT	AL TREES		_
7	AG	AUTUMN BRILLIANCE SERVICEBERRY	Amelanchir x grandiflora 'Autumn Brilliance'	2"
6	MD	GLADIATOR CRABAPPLE	Malus x adstringens 'Durleo' (PP20,167)	2"
9	SR	IVORY SILK JAPANESE TREE LILAC	Syringa reticulata 'Ivory Silk'	2"
EVER	GREE	N SHRUBS		
9	Bg	CHICAGOLAND GREEN BOXWOOD	Buxus X 'Glencoe'	#5 (
26	Jc	SPARTAN JUNIPER	Juniperus chinensis 'Spartan'	6'
18	Jm	MANEY JUNIPER	Juniperus chinensis 'Maneyi'	#5 (
20	То	TECHNITO ARBORVITAE	Thuja occidentalis 'Balijohn'	4' F
DECII	buous	TREES		
7	AS	GREEN MOUNTAIN SUGAR MAPLE	Acer saccharum 'Green Mountain'	2.5'
6	BN	RIVER BIRCH	Betula nigra	2.5'
6	BP	DAKOTA PINNACLE BIRCH	Betula platyphylla 'Fargo'	2.5'
1	GB	AUTUMN GOLD GINKGO	Ginkgo Biloba 'Autumn Gold'	2.5'
8	GT	SKYLINE HONEYLOCUST	Gleditsia triacanthos var. inermis 'Skycole'	2.5'
6	PT	PRAIRIE GOLD ASPEN	Populus tremuloides 'NEArb'	2.5'
8	QA	QUAKING ASPEN	Populous tremuloides	#20
7	QB	SWAMP WHITE OAK	Quercus bicolor	2.5'
5	TA	AMERICAN SENTRY LINDEN	Tilia americana 'MnKSentry'	2.5'
DECII	DUOUS	SHRUBS	,	
63	Am	LOW SCAPE MOUND CHOKEBERRY	Aronia melanocarpa 'UCONN 165' (PP28, 789)	#2 (
8	Cb	IVORY HALO DOGWOOD	Cornus alba 'Bailhalo'	#5 (
18	Сс	SUGARTINA CLETHRA	Clethra alnifolia 'Crystalina' (PP21, 561)	#2 (
32	Ds	BUTTERFLY BUSH HONEYSUCKLE	Diervilla sessilifolia 'Butterfly'	#5 (
32	Mm	IRIQUOIS BEAUTY BLACK CHOKEBERRY	Aronia melanocarpa 'Morten'	#5 (
24	Ra	ALPINE CURRANT	Ribes alpinum	#5 (
19	Rg	GRO LOW SUMAC	Rhus aromatica 'Gro Low'	#5 (
52	Rn	FLOWER CARPET ROSE	Rosa x 'Noamel'	#1 (
33	Ss	SEM FALSE SPIREA	Sorbaria sorbifolia 'Sem'	#5 (
		JS TREES	1	
12	PA	NORWAY SPRUCE	Picea abies	8'
7	PS	WHITE PINE	Pinus Strobus	6'

KEY NOTES:

- L4 C.I.P. COLORED CONCRETE (A), CEMSTONE 'HARBOR MIST' CPC 120-L'; JOINTING PER PLAN, 3/8" SAWN
- JOINTS, SEE SPEC. C.I.P. COLORED CONCRETE (B), CEMSTONE 'MORCHELLA GOLD' CPC 144-L'; JOINTING PER PLAN, 3/8" SAWN
- JOINTS, SEE SPEC. C.I.P. CONCRETE PLANTER CURB OVER STRUCTURE, 6" W X 6" T X 18" D; SEE X/L3XX
- PRIVATE PATIO, C.I.P. PLAIN CONC., SEE ARCH. FOR STOOP CONNECTION DRY STACKED BLOCK PLANTER WALL WITHOUT CAP BLOCK, ROCHESTER CONCRETE 'CONTEMPORARY WALL' CASCADE COLOR, 20" FINISHED HEIGHT, SEE X/L3XX
- FESTOON LIGHTING, SEE ELEC. FOR PRODUCT, SEE X/L3XX FOR ATTACHEMENTS PLANTING BED, HARDWOOD MULCH; 4" DEPTH, PROVIDE AUTOMATED DRIP IRRIGATION AND STEEL
- LANDSCAPE EDGER; SEE 1 AND 2/L300 SEE 3/L300 FOR STEEL EDGER DETAIL SYNTHETIC TURF SYSTEM, SYNLAWN 'AUGUSTINE X47', INSTALLED PER MANUFACT. SPEC(S)
- PERGOLA, TREX 'ELEMENT', 12'W X 16'L, JET BLACK FINISH, CONCRETE MOUNTING KIT, INSTALLED PER
- DECORATIVE ROCK MULCH SURFACING, 3/8" TRACK ROCK, CLEAN, 3" MIN. DEPTH, FILTER FABRIC UNDERLAYMENT, TYP. BENCH (A); 'VILNIUS' BY LANDSCAPE FORMS, BLACK ACID ETCHED FINISH, SURFACE MOUNT PER
- MANUFACT. SPEC(S), (5 TOTAL UNITS) BENCH (B); 'PARALLEL 42 WEDGE 30' BY LANDSCAPE FORMS, 'STEEL' POWDERCOATED FRAME, DSTMA
- WOOD, SURFACE MOUNTED PER MANUFACT. SPEC(S), (2 TOTAL UNITS)
- BIKE RACK; DERO "HOOP", STAINLESS FINISH, (4 TOTAL UNITS) SURFACE MOUNTED PER MANUFACT. L29 FREESTANDING FURNISHINGS; FFE BY OWNER
- TRASH AND RECYCLING UNIT, LANDSCAPE FORMS 'SELECT' DOUBLE UNIT, BLACK POWDERCOATED FINISH (2 TOTAL UNITS)
- GAS FIRE PIT; 'ROBATA 72" BY PALOFORM, 'NOUGAT' COLOR, 'GRAPHITE' POWDER COAT COVER, DARK GREY RIVER ROCK TOPPING, SEE MECH. FOR EMERGENCY SHUT OFF AND TIMER VALVE LOCATIONS 6' STEEL PCIKET SECURITY FENCE; AMERISTAR 'MONTAGE PLUS MAJESTIC STYLE', BLACK
- PLATE, INSTALLED AT GRADE PER MANUFACT. SPEC(S) FREESTANDING PLANTERS (A) WITHOUT SUBSURFACE IRRIGATION CONNECTION; TOURNESOL 'BOULEVARD SQUARE', 24"SQ X 24"T, 'WESTERN RED CEDAR' FINISH, SEASONAL DECORATIONS BY OWNER


POWDERCOATED FINISH, INCLUDE FOB KEY ACCESS, PANIC BAR HARDWARE, AND TAMPER PROOF ENTRY


- FREESTANDING PLANTERS (B) WITH SUBSURFACE IRRIGATION CONNECTION; TOURNESOL 'BOULEVARD RECTANGLE', 60"L X 18"W X 36"T, 'WESTERN RED CEDAR' FINISH (2 TOTAL UNITS)
- L39 SPA AREA, SEE POOL VENDOR FOR DRAWINGS BAR RAIL, 'JESSIE' BY LANDSCAPE FORMS, BLACK POWDERCOATED FRAME WITH 3-SLATTED DSTMA BAR TOP, SURFACE MOUNTED PER MANUFACT. SPEC(S).
- GREEN ROOF BLANKET SYSTEM, SEMPER GREEN 'STANDARD SEDUM MIX', INSTALLED PER MANUFACT.
- BUILT-IN NATURAL GAS BAR AND GRILL STATION, GRANITE COUNTERTOP, BRICK CLADDING TO MATCH BUILDING SEE X/L3XX
- PEDESTAL PAVER SYSTEM, WAUSAU TILE 'STONEY CREEK SC-40', 16"W X 36"L, INSTALLED PER MANUFACT.


STEPPER STONE PAVERS, DRY LAID, WAUSAU TILE 'STONEY CREEK SC-40', 16"W X 36"L, INLAID IN MULCH


BURRIED 1" BELOW FINISHED MULCH HEIGHT L51 C.I.P. COLORED CONCRETE (A) SLOPED WALK (5% MAX SLOPE), CEMSTONE 'HARBOR MIST' CPC 120-L';


JOINTING PER PLAN, 3/8" SAWN JOINTS, SEE SPEC.

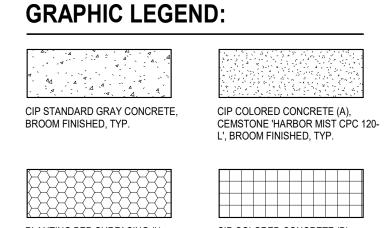

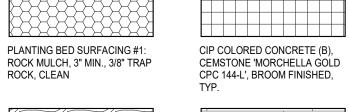

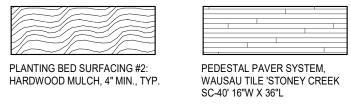


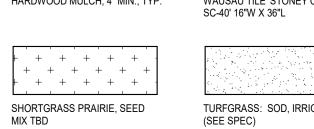

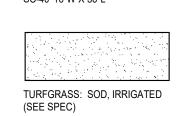



DOG RUN, 3/4" PEA GRAVEL, CLEAN, 6" MIN. DEPTH, TYP.

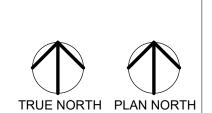

Architecture

Interior Design Landscape Architecture Engineering

222 North Second Street Long & Kees Bldg Suite 101 Minneapolis, MN

www.bkvgroup.com

612.339.3752

CONSULTANTS

PROJECT TITLE

4917 EDEN AVE

ISSUE # DATE DESCRIPTION
10/05/2021 FINAL DEVELOPMENT SET

CERTIFICATION

CHECKED BY COMMISSION NUMBER 2286-05 SHEET TITLE

> COURTYARD -LANDSCAPE **PLANS**

SHEET NUMBER

© 2019 BKV Group

3 LEVEL 3 TERRACE - LANDSCAPE PLAN
L150 1" = 10'-0"

KEY NOTES:

L49 PEDESTAL PAVER SYSTEM, WAUSAU TILE 'STONEY CREEK SC-40', 16"W X 36"L, INSTALLED PER MANUFACT. SPEC(S)

GRAPHIC LEGEND:

CIP STANDARD GRAY CONCRETE,
BROOM FINISHED, TYP.

CIP COLORED CONCRETE (A),
CEMSTONE 'HARBOR MIST CPC 120L', BROOM FINISHED, TYP.

PLANTING BED SURFACING #1: ROCK MULCH, 3" MIN., 3/8" TRAP ROCK, CLEAN CIP COLORED CONCRETE (B), CEMSTONE 'MORCHELLA GOLD CPC 144-L', BROOM FINISHED,

PLANTING BED SURFACING #2: PEDESTAL PAVER SYSTEM,
HARDWOOD MULCH, 4" MIN., TYP. WAUSAU TILE 'STONEY CREEK
SC-40' 16"W X 36"L

SHORTGRASS PRAIRIE, SEED MIX TBD

TURFGRASS: SOD, IRRIGATED (SEE SPEC)

DOG RUN, 3/4" PEA GRAVEL, CLEAN, 6" MIN. DEPTH, TYP.

SHEET NUMBER

© 2019 BKV Group

COMMISSION NUMBER 2286-05

ROOFTOP -

LANDSCAPE

PLANS

CERTIFICATION

DRAWN BY CHECKED BY

SHEET TITLE

2 ROOFTOP GARDEN PLOTS - LANDSCAPE PLAN
1/16" = 1'-0"

TRUE NORTH PLAN NORTH

Architecture Interior Design

Engineering .

Landscape Architecture

222 North Second Street

Long & Kees Bldg Suite 101

Minneapolis, MN 55401

www.bkvgroup.com

612.339.3752

PROJECT TITLE 4917 EDEN AVE

ISSUE # DATE DESCRIPTION
10/05/2021 FINAL DEVELOPMENT SET

8'0" MAX SPACING O.C

SHRUB AND PERENNIAL PLANTING DETAILS-TYP.

3/4" = 1'-0"

PRIOR TO FINAL APPROVAL.

2. ANCHOR BOLTS BY RAIL SUPPLIER.

6' STEEL FENCE; SURFACE MOUNTED ON C.I.P. CONC. FOUNDATION, TO MATCH AMERISTAR FENCE SEGMENT

PERFORATED METAL PANEL; MIN. 60% OPACITY, PATTERN TBD. -

6" SQ. X 1/2" BASE PLATE ; POST TO BE ANCHORED TO -CONCRETE SLAB WITH 4" S.S. BOLTS

3 DECORATIVE METAL SCREEN FENCE DETAIL

3 3/4" = 1'-0"

1. POSTS, FRAMES, SPACERS, HARDWARE, AND WELDS TO BE FINISHED WITH BLACK


POWDER COAT OR EQUAL. CONTRACTOR SHALL SUBMIT SHOP DRAWINGS FOR LA REVIEW

1 1/2" SQ. BOTTOM RAIL -

2" MIN. CLEARANCE

FINISH GRADE

ALLEY PAVEMENT

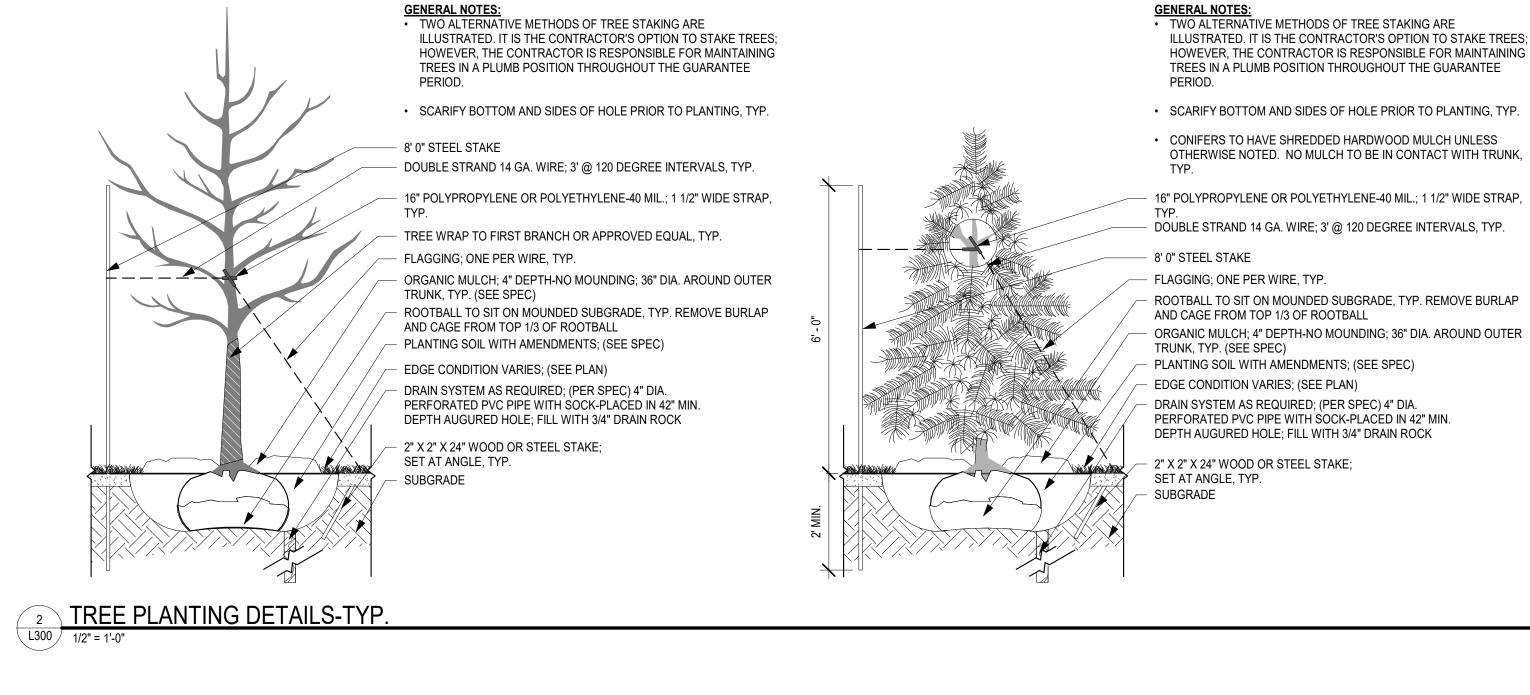

----- 1 1/2" TOP RAIL

2 1/2" POST, 16 GAUGE STEEL

3/4" PICKETS, 18 GAUGE STEEL

GENERAL NOTES:

• TWO ALTERNATIVE METHODS OF TREE STAKING ARE ILLUSTRATED. IT IS THE CONTRACTOR'S OPTION TO STAKE TREES; HOWEVER, THE CONTRACTOR IS RESPONSIBLE FOR MAINTAINING TREES IN A PLUMB POSITION THROUGHOUT THE GUARANTEE

GROUP GROUP

Architecture
Interior Design
Landscape Architecture
Engineering

222 North Second Street Long & Kees Bldg Suite 101

612.339.3752

Minneapolis, MN

www.bkvgroup.com

CONSULTANTS

PROJECT TITLE

4917 EDEN AVE

ISSUE # DATE DESCRIPTION
10/05/2021 FINAL DEVELOPMENT SET

CERTIFICATION

CONSTRUCTION

CHECKED BY
COMMISSION NUMBER 2286-05
SHEET TITLE

LANDSCAPE DETAILS

SHEET NUMBER

L300

