


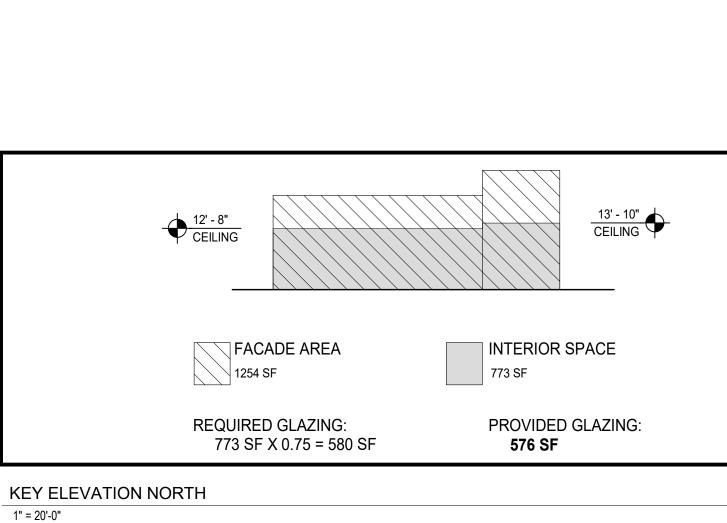



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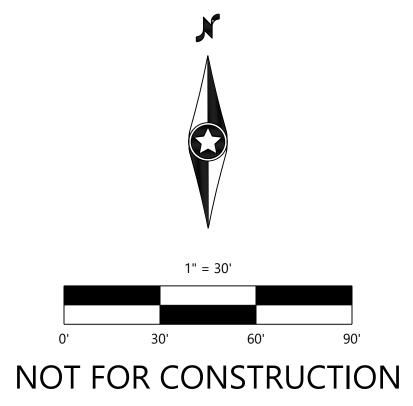


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Common Ground Allia

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SANITARY MANHOLE	\otimes	STEEL/WOOD POST
SEWER CLEANOUT	-	SIGN
SEPTIC COVER	MAIL	MAIL BOX
STORM MANHOLE	~0	FLAG POLE
BEEHIVE CATCH BASIN	Ê.	HANDICAPPED STALL
CATCH BASIN		BENCH
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CULVERT	E)	OIL PUMP JACK
CATCH BASIN MANHOLE		OIL WELL
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ELECTRIC BOX		RIGHT-OF-WAY LINE
ELECTRIC METER		LOT LINE
ELECTRIC MANHOLE		EASEMENT LINE
ELECTRIC TOWER		SECTION LINE
STREET LIGHT		TREE LINE
POWER POLE WITH LIGHT	CTV	CABLE TELEVISION LINE
GUY WIRE	GAS	GAS LINE
POWER POLE	—— РОН ———	POWER OVERHEAD
MAST ARM	PUG	POWER UNDERGROUND
MAST ARM W/ LIGHT	SAN	SANITARY SEWER
TRAFFIC SIGNAL	STO	STORM SEWER
TELEPHONE BOX	——— тон ———	TELEPHONE OVERHEAD
TELEPHONE MANHOLE	TUG	TELEPHONE UNDERGROUND
HAND HOLE/JUNCTION BOX	WAT	WATERMAIN
CABLE TV BOX	FO	FIBER OPTIC
CABLE TV MANHOLE	X	FENCE LINE
FIBER OPTIC MANHOLE	Δ	CONTROLLED ACCESS
FIBER OPTIC PEDESTAL		CURB & GUTTER
NATURAL GAS METER		CONCRETE SURFACE
NATURAL GAS VALVE		BITUMINOUS SURFACE
NATURAL GAS MANHOLE		GRAVEL SURFACE
NATURAL GAS RISER/SERVICE		WETLAND
NATURAL GAS VENT PIPE	•	FOUND MONUMENT (SEE LABEL)
NATURAL GAS WELL	0	SET MONUMENT (SEE LABEL)
AIR CONDITIONER		
UNKNOWN MANHOLE		

MISCELLANEOUS METER

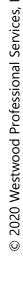
MISCELLANEOUS PEDESTAL

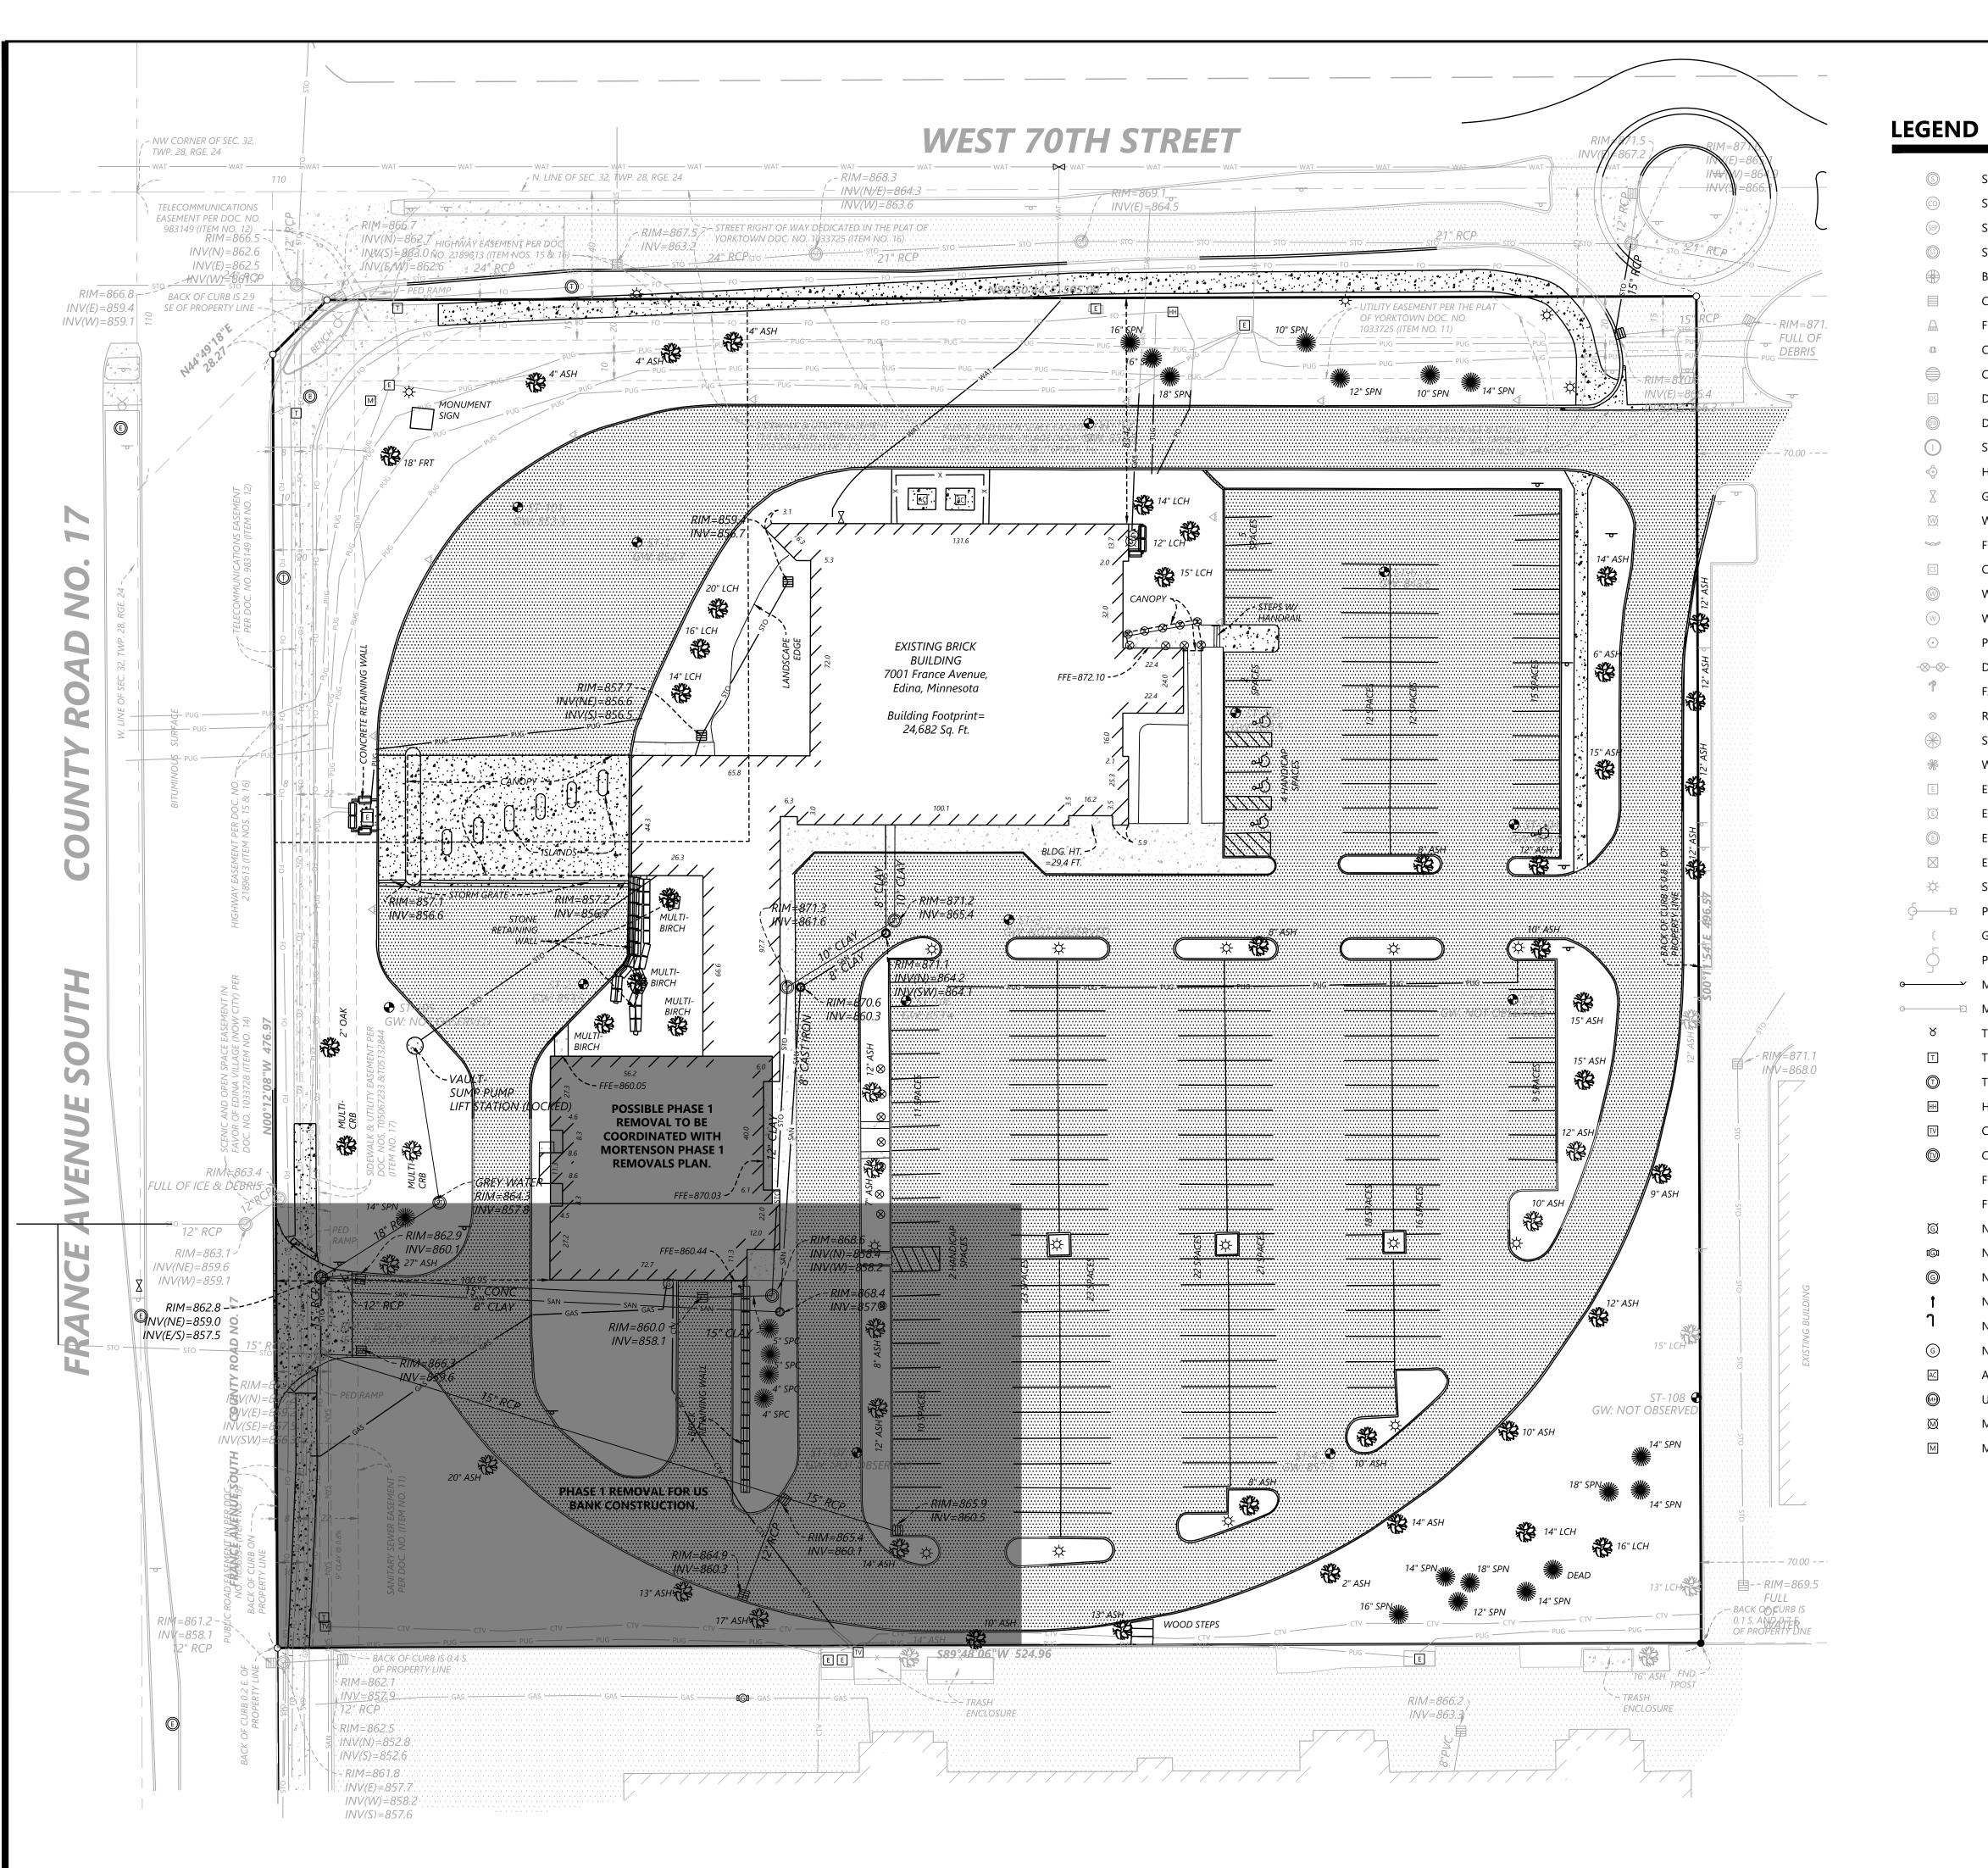


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Description Desc	C1	Westwood		I HEREBY CERTIFY THAT THIS PLAN WAS PREPARED BY ME OR UNDER MY DIRECT SUPERVISION AND THAT I AM A DULY LICENSED PROFESSIONAL ENGINEER UNDER THE LAWS	PREPARED FOR:	INITIAL ISSUE: 11/16/2020 REVISIONS: A 01/05/0001 INE PANIV FINIAL PRAFILE PLANE	DESIGNED: CHECKED:
DAVID T. BADE 120 MASHALL STRET NE 06/04/2021 CITY OF EDINA SITE UPDATE VERTICAL E CONTAL SCALE: ## CONTAL SCALE:	0	Ø	US BANK - EDINA	OF THE STATE OF MINNESOTA	RSP ARCHITECTS	O 1/25/2021 US BAINT FINAL DEVELOPMENT FLANS 02/26/2021 WATERSHED COMMENTS	DRAWN:
	202	Toll Free (888) 937-5750 westwoodps.com Westwood Professional Services. Inc.		DAVID T. BADE	1220 MARSHALL STREET NE		
	1		EUINA, MIN	DATE: UZ/ Z0/ ZUZ I LICENSE NO.	MINNEAPOLIS, MN 55413		

90'



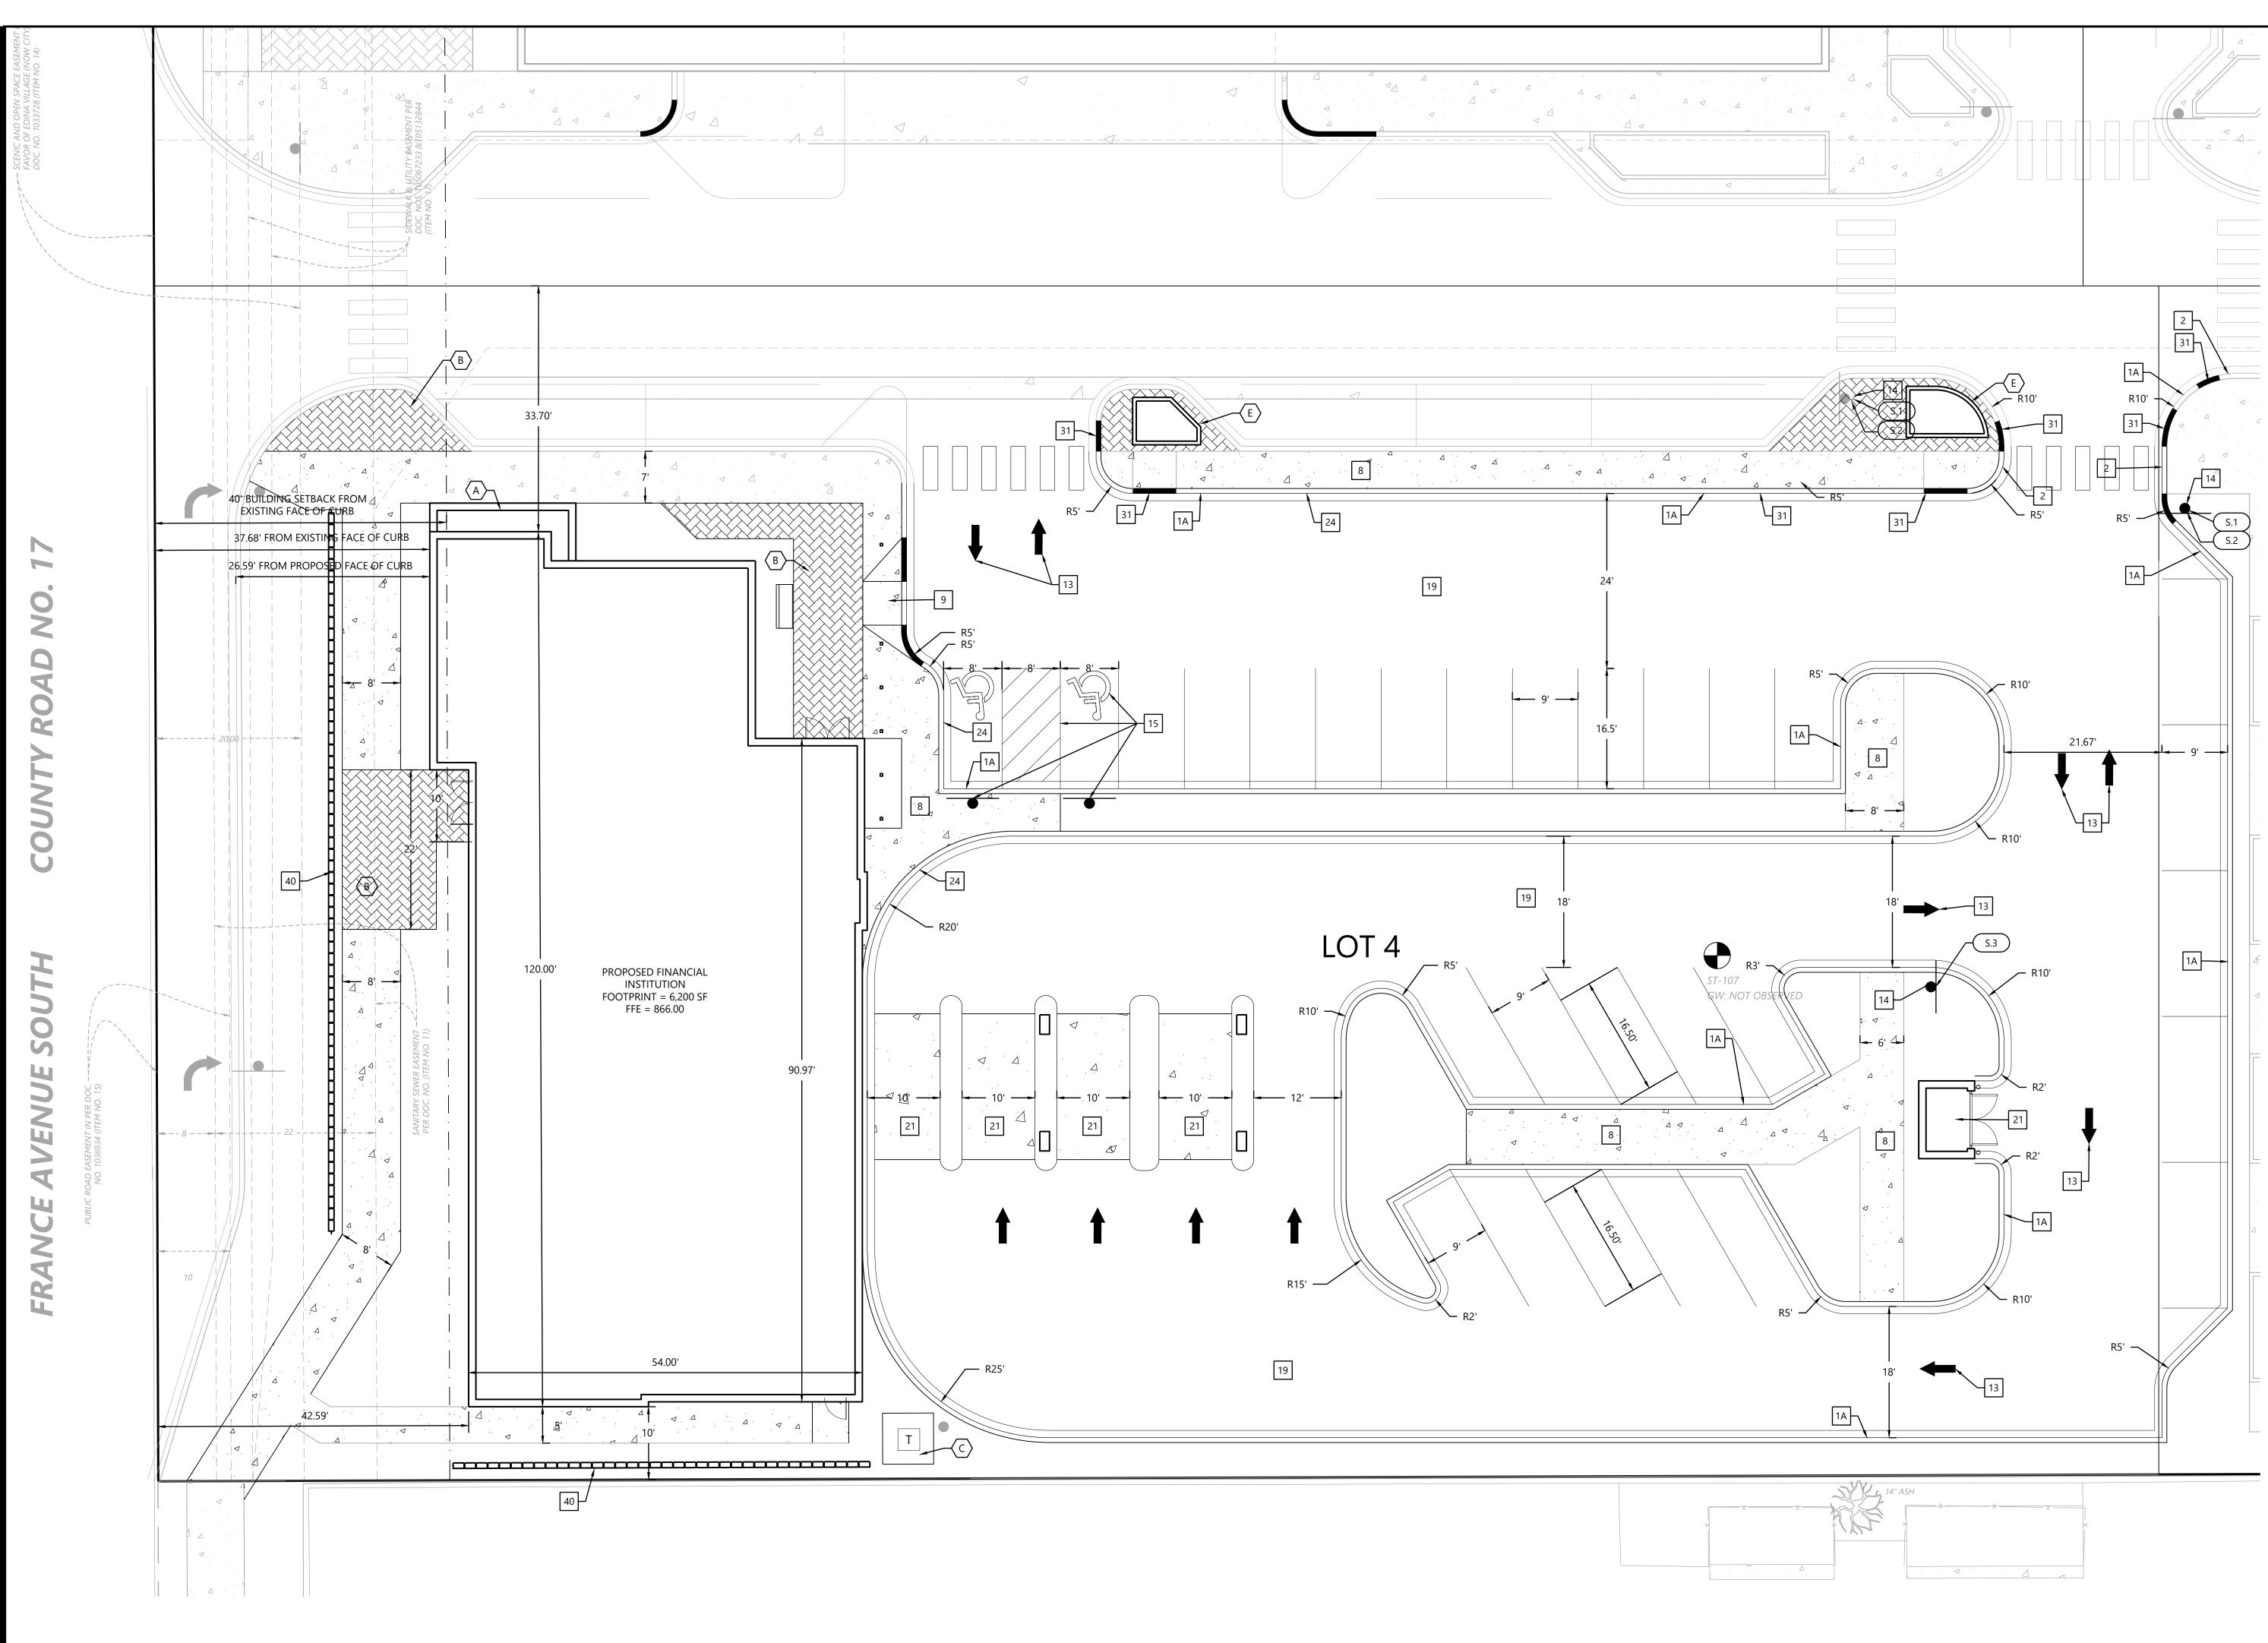

SITE LEGEND

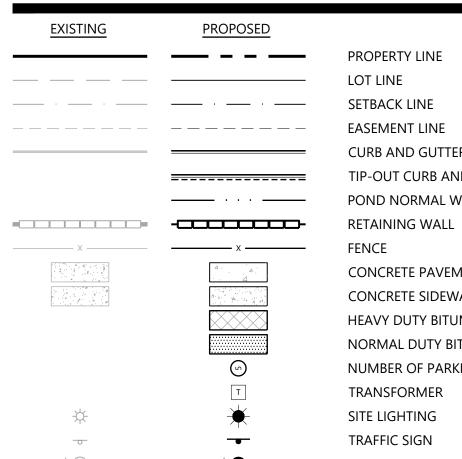

GENERAL SITE NOTES

- 1. BACKGROUND INFORMATION FOR THIS PROJECT PROVIDED BY WESTWOOD PROFESSIONAL SERVICES, MINNETONKA, MN, 2020.
- 2. LOCATIONS AND ELEVATIONS OF EXISTING TOPOGRAPHY AND UTILITIES AS SHOWN ON THIS PLAN ARE APPROXIMATE. CONTRACTOR SHALL FIELD VERIFY SITE CONDITIONS AND UTILITY LOCATIONS PRIOR TO EXCAVATION/CONSTRUCTION. IF ANY DISCREPANCIES ARE FOUND, THE ENGINEER SHOULD BE NOTIFIED IMMEDIATELY.
- 3. REFER TO BOUNDARY SURVEY FOR LOT BEARINGS, DIMENSIONS AND AREAS.
- 4. ALL DIMENSIONS ARE TO FACE OF CURB OR EXTERIOR FACE OF BUILDING UNLESS OTHERWISE NOTED.
- 5. REFER TO ARCHITECTURAL PLANS FOR EXACT BUILDING DIMENSIONS AND LOCATIONS OF EXITS, RAMPS, AND TRUCK DOCKS.
- 6. ALL CURB RADII ARE SHALL BE 5.0 FEET (TO FACE OF CURB) UNLESS OTHERWISE NOTED.
- 7. ALL CURB AND GUTTER SHALL BE B612 UNLESS OTHERWISE NOTED.
- 8. THE CONTRACTOR SHALL BE RESPONSIBLE FOR PROVIDING AND MAINTAINING TRAFFIC CONTROL DEVICES SUCH AS BARRICADES, WARNING SIGNS, DIRECTIONAL SIGNS, FLAGGERS AND LIGHTS TO CONTROL THE MOVEMENT OF TRAFFIC WHERE NECESSARY. PLACEMENT OF THESE DEVICES SHALL BE APPROVED BY THE CITY AND ENGINEER PRIOR TO PLACEMENT. TRAFFIC CONTROL DEVICES SHALL CONFORM TO APPROPRIATE MNDOT STANDARDS.
- 9. BITUMINOUS PAVEMENT AND CONCRETE SECTIONS TO BE IN ACCORDANCE WITH THE RECOMMENDATIONS OF THE GEOTECHNICAL ENGINEER.
- CONSTRUCTION AND TAKE ALL PRECAUTIONS NECESSARY TO AVOID PROPERTY DAMAGE TO ADJACENT PROPERTIES.
- 11. SITE LIGHTING SHOWN ON PLAN IS FOR REFERENCE ONLY. REFER TO LIGHTING PLAN PREPARED BY OTHERS FOR SITE LIGHTING DETAILS AND PHOTOMETRICS.

SITE DEVELOPMENT SUMMARY

• EXISTING ZONING:

- PROPOSED ZONING:
- PARCEL DESCRIPTION:
- PROPERTY AREA:
- FLOOR-AREA-RATIO(FAR):
- BUILDING SETBACK PER CODE:

SITE DETAILS (SI-0XX)


- 1A B612 CURB AND GUTTER 1B B618 CURB AND GUTTER
- 2 FLUSH CURB
- 8 PRIVATE CONCRETE SIDEWALK 9 PRIVATE PEDESTRIAN CURB RAMP
- 13 TRAFFIC ARROW
- 14 SIGN INSTALLATION 15 HANDICAP ACCESSIBLE SIGNAGE AND STRIPING
- 19 PAVEMENT SECTIONS 21 HEAVY DUTY CONCRETE SECTION
- 24 CONCRETE CURB AT SIDEWALK
- 31 TRANSITION CURB (B612) 40 MODULAR BLOCK RETAINING WALL

SITE KEYNOTES


- A. LIMESTONE BLOCK WALL SEE ARCH PLANS
- B. CONCRETE PAVERS SEE LANDSCAPE PLAN
- TRANSFORMER LOCATION D. TRASH ENCLOSURE - SEE ARCH PLANS
- E. PLANTER CURB SEE LANDSCAPE PLAN


SIGN LEGEND

- REFERENCE
- S.1 STOP SIGN
- S.2 PEDESTRIAN CROSSING
- S.3 DO NOT ENTER

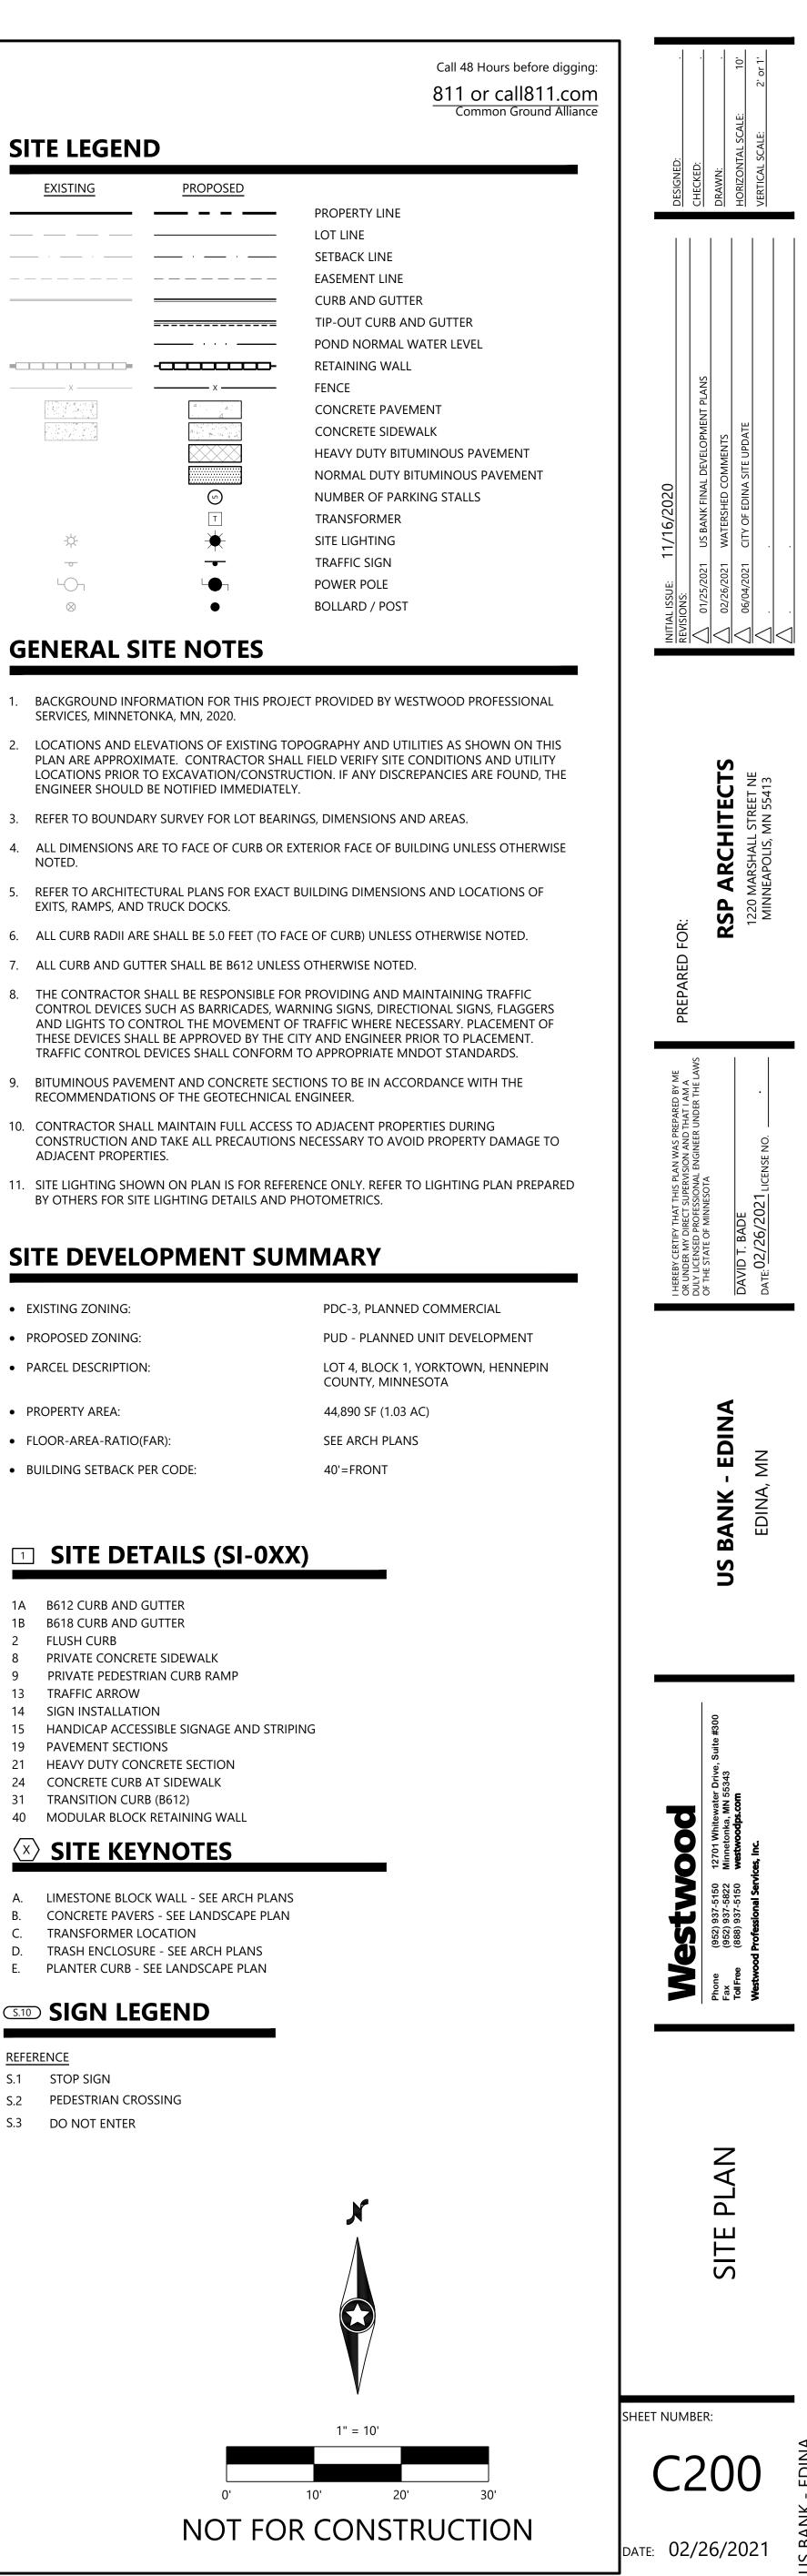



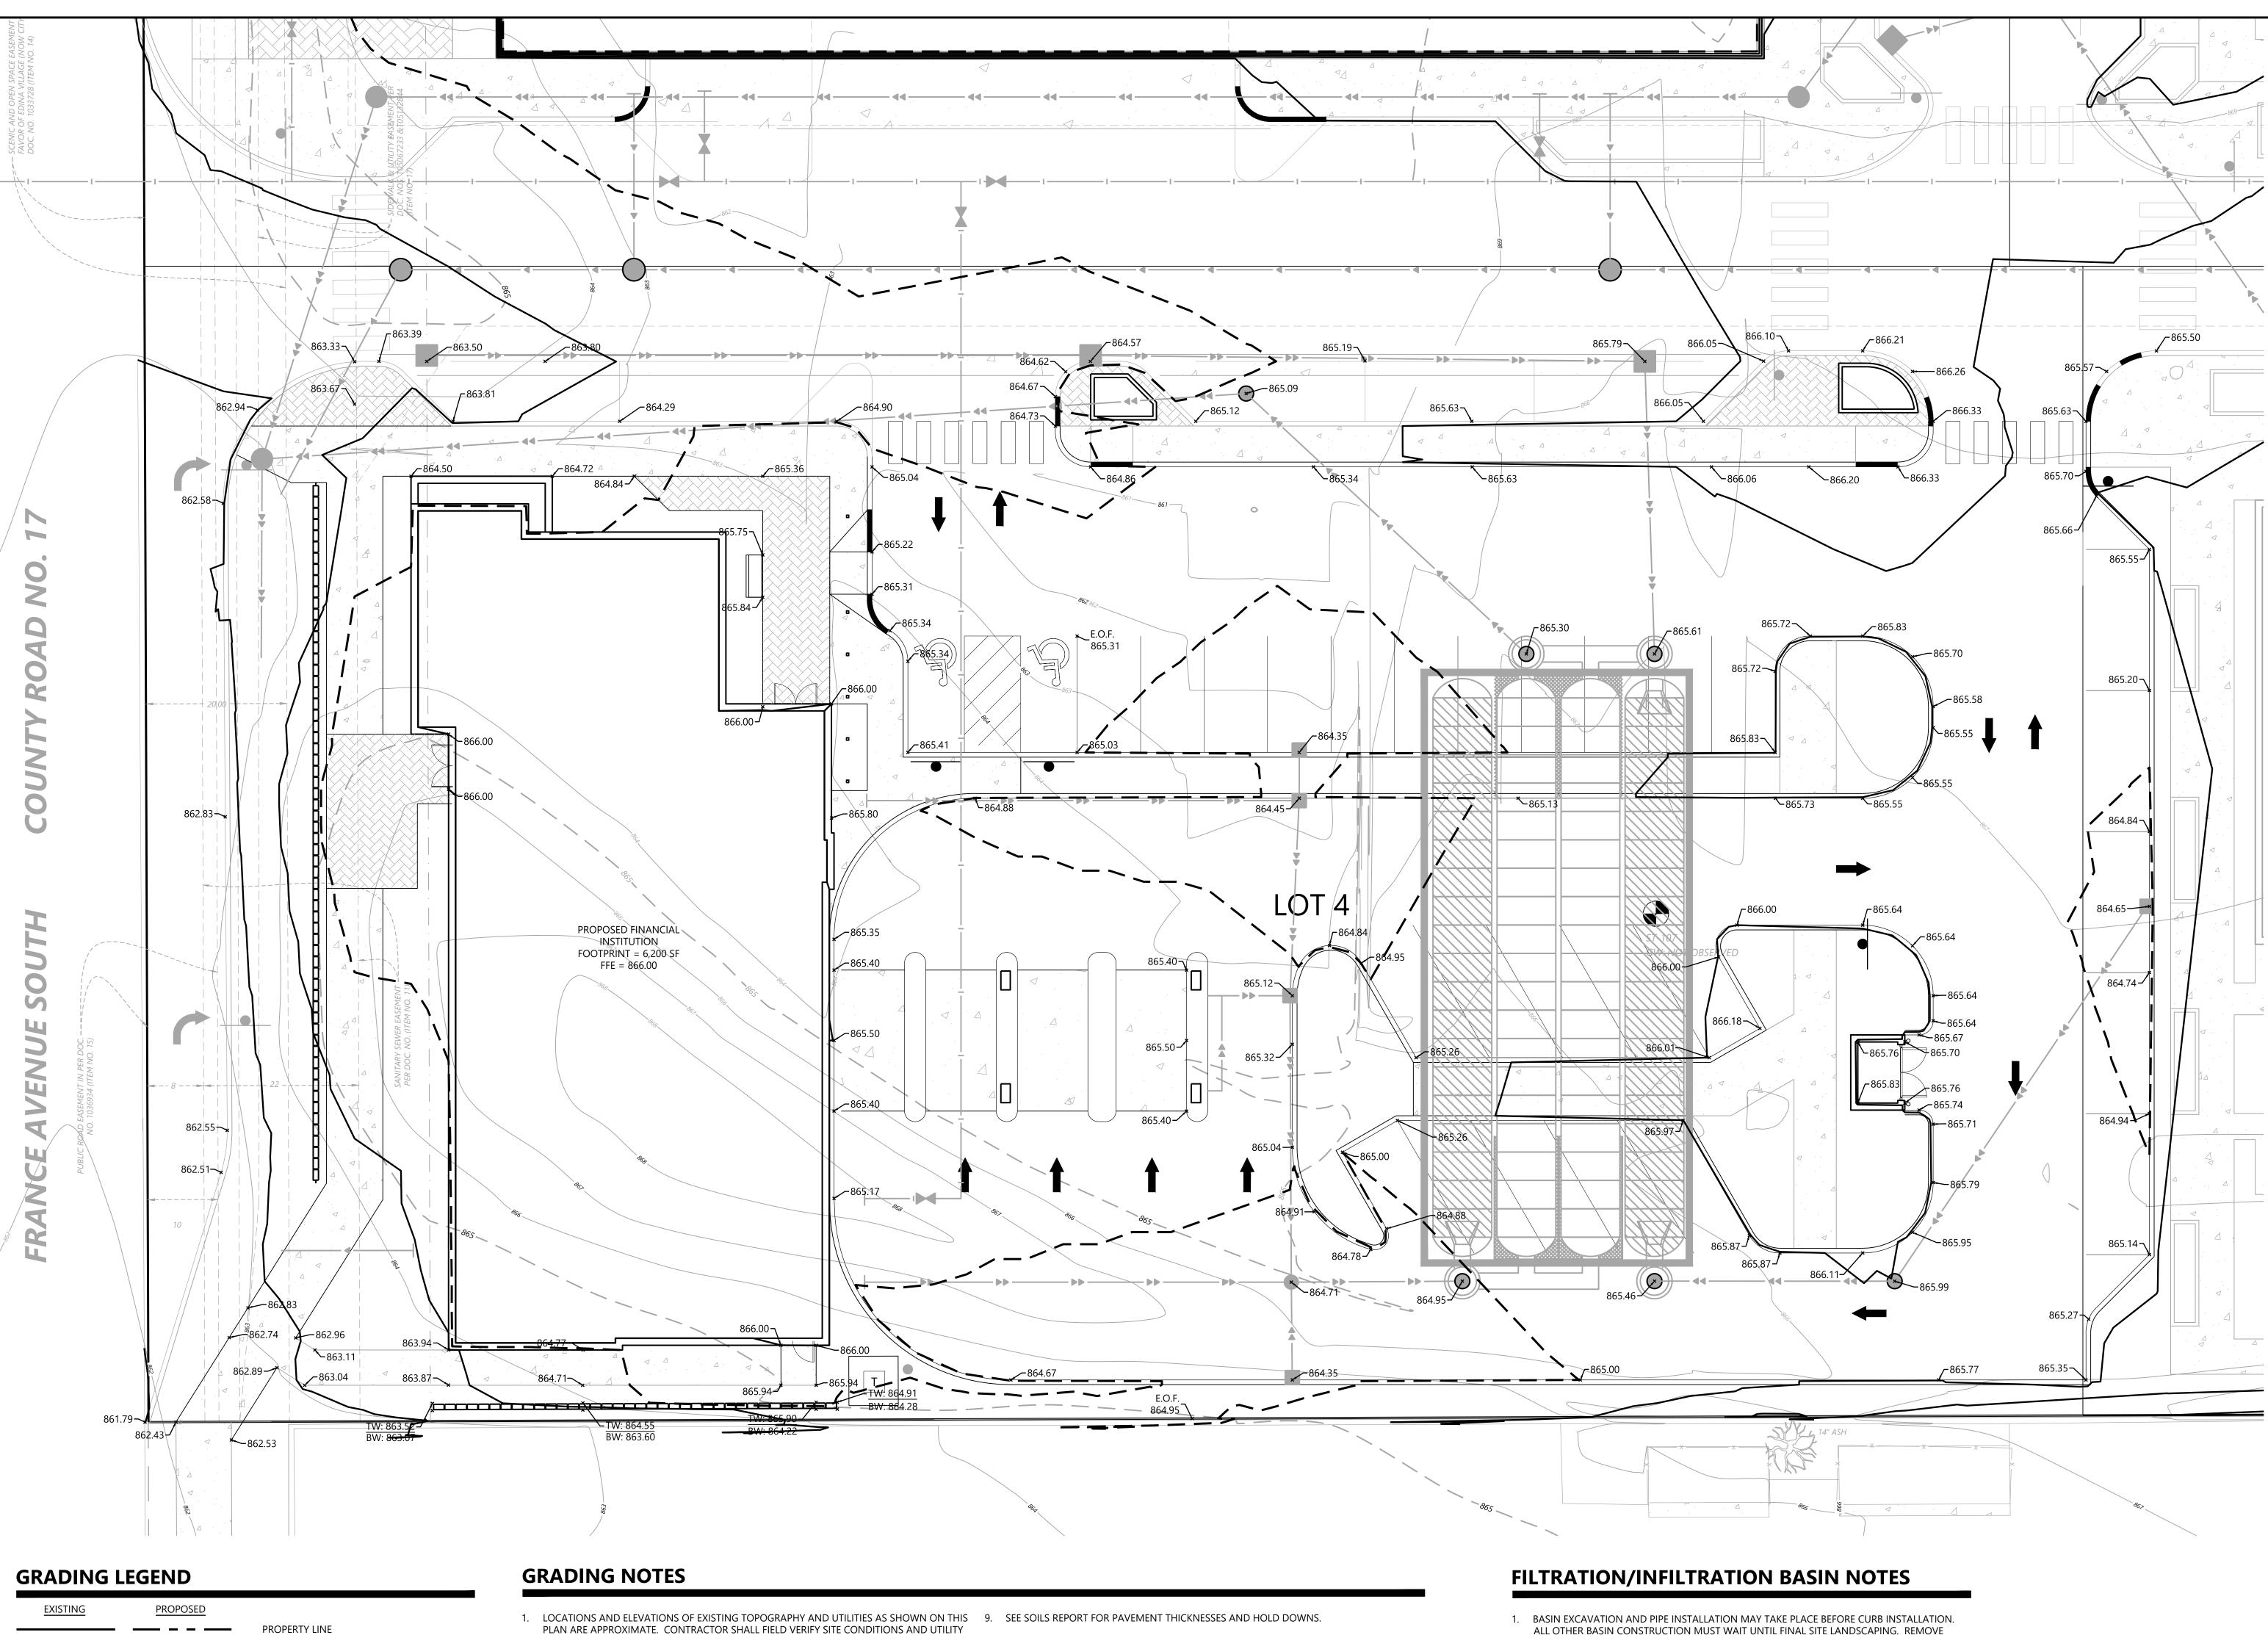

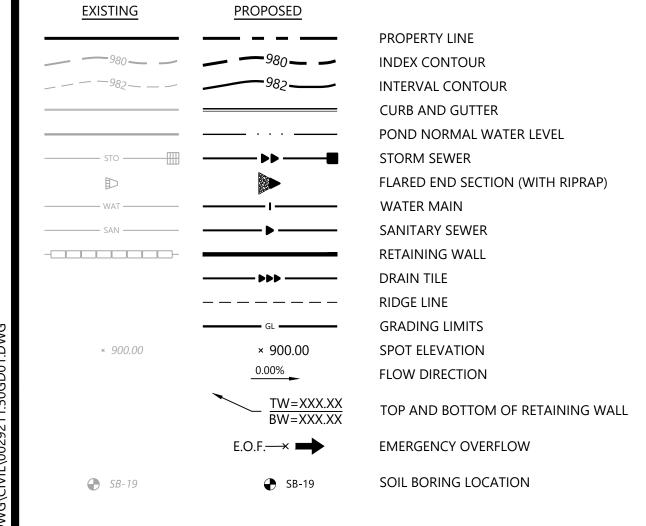

- LOCATIONS PRIOR TO EXCAVATION/CONSTRUCTION. THE ENGINEER SHALL BE NOTIFIED IMMEDIATELY IF ANY DISCREPANCIES ARE FOUND.
- 2. CONTRACTORS SHALL REFER TO ARCHITECTURAL PLANS FOR EXACT LOCATIONS AND DIMENSIONS OF VESTIBULE, SLOPED PAVEMENT, EXIT PORCHES, RAMPS, TRUCK DOCKS, PRECISE BUILDING DIMENSIONS, EXACT BUILDING UTILITY ENTRANCE LOCATIONS, AND EXACT 11. CONTRACTOR SHALL PROVIDE A STRUCTURAL RETAINING WALL DESIGN CERTIFIED BY A LOCATIONS AND NUMBER OF DOWNSPOUTS.
- 3. ALL EXCAVATION SHALL BE IN ACCORDANCE WITH THE CURRENT EDITION OF "STANDARD 12. ALL CONSTRUCTION SHALL CONFORM TO LOCAL, STATE AND FEDERAL RULES INCLUDING THE SPECIFICATIONS FOR TRENCH EXCAVATION AND BACKFILL/SURFACE RESTORATION" AS PREPARED BY THE CITY ENGINEERS ASSOCIATION OF MINNESOTA.
- 13. PRIOR TO PLACEMENT OF ANY STRUCTURE OR PAVEMENT, A PROOF ROLL, AT MINIMUM, WILL 4. ALL DISTURBED UNPAVED AREAS ARE TO RECEIVE FOUR INCHES OF TOPSOIL AND SOD OR BE REQUIRED ON THE SUBGRADE. PROOF ROLLING SHALL BE ACCOMPLISHED BY MAKING SEED. THESE AREAS SHALL BE WATERED UNTIL A HEALTHY STAND OF GRASS IS OBTAINED. SEE MINIMUM OF 2 COMPLETE PASSES WITH FULLY-LOADED TANDEM-AXLE DUMP TRUCK, OR LANDSCAPE PLAN FOR PLANTING AND TURF ESTABLISHMENT. APPROVED EQUAL, IN EACH OF 2 PERPENDICULAR DIRECTIONS WHILE UNDER SUPERVISION AND DIRECTION OF THE INDEPENDENT TESTING LABORATORY. AREAS OF FAILURE SHALL BE 5. THE CONTRACTOR SHALL BE RESPONSIBLE FOR PROVIDING AND MAINTAINING TRAFFIC EXCAVATED AND RE-COMPACTED AS SPECIFIED HEREIN.
- CONTROL DEVICES SUCH AS BARRICADES, WARNING SIGNS, DIRECTIONAL SIGNS, FLAGMEN AND LIGHTS TO CONTROL THE MOVEMENT OF TRAFFIC WHERE NECESSARY. PLACEMENT OF 14. EMBANKMENT MATERIAL PLACED BENEATH BUILDINGS AND STREET OR PARKING AREAS THESE DEVICES SHALL BE APPROVED BY THE ENGINEER PRIOR TO PLACEMENT. TRAFFIC SHALL BE COMPACTED IN ACCORDANCE WITH THE SPECIFIED DENSITY METHOD AS OUTLINED CONTROL DEVICES SHALL CONFORM TO APPROPRIATE MNDOT STANDARDS. IN MNDOT 2105.3F1 AND THE REQUIREMENTS OF THE GEOTECHNICAL ENGINEER.
- 6. ALL SLOPES SHALL BE GRADED TO 3:1 OR FLATTER, UNLESS OTHERWISE INDICATED ON THIS 15. EMBANKMENT MATERIAL NOT PLACED IN THE BUILDING PAD, STREETS OR PARKING AREA, SHEET.
- 7. CONTRACTOR SHALL UNIFORMLY GRADE AREAS WITHIN LIMITS OF GRADING AND PROVIDE A SMOOTH FINISHED SURFACE WITH UNIFORM SLOPES BETWEEN POINTS WHERE ELEVATIONS 16. ALL SOILS AND MATERIALS TESTING SHALL BE COMPLETED BY AN INDEPENDENT ARE SHOWN OR BETWEEN SUCH POINTS AND EXISTING GRADES.
- 8. SPOT ELEVATIONS SHOWN INDICATE FINISHED PAVEMENT ELEVATIONS & GUTTER FLOW LINE UNLESS OTHERWISE NOTED. PROPOSED CONTOURS ARE TO FINISHED SURFACE GRADE.

- 10. CONTRACTOR SHALL DISPOSE OF ANY EXCESS SOIL MATERIAL THAT EXISTS AFTER THE SITE GRADING AND UTILITY CONSTRUCTION IS COMPLETED. THE CONTRACTOR SHALL DISPOSE OF ALL EXCESS SOIL MATERIAL IN A MANNER ACCEPTABLE TO THE OWNER AND THE REGULATING AGENCIES.
- LICENSED PROFESSIONAL ENGINEER.
- NATIONAL POLLUTANT DISCHARGE ELIMINATION SYSTEM (NPDES) PERMIT REQUIREMENTS.
- SHALL BE COMPACTED IN ACCORDANCE WITH REQUIREMENTS OF THE ORDINARY COMPACTION METHOD AS OUTLINED IN MNDOT 2105.3F2.
- GEOTECHNICAL ENGINEER. EXCAVATION FOR THE PURPOSE OF REMOVING UNSTABLE OR UNSUITABLE SOILS SHALL BE COMPLETED AS REQUIRED BY THE GEOTECHNICAL ENGINEER. THE CONTRACTOR SHALL BE RESPONSIBLE FOR COORDINATING ALL REQUIRED SOILS TESTS AND INSPECTIONS WITH THE GEOTECHNICAL ENGINEER.

- BASINS ARE ON-LINE.

SOIL REPLACEMENT NOTE

GEOTECHNICAL EVALUATIONS FOUND A LAYER OF CLAYEY SAND APPROXIMATELY 4 FEET BELOW THE BOTTOM OF THE PROPOSED INFILTRATION CHAMBERS. SHOULD THIS MATERIAL BE ENCOUNTERED DURING CONSTRUCTION, THE EXISTING CLAYEY SAND MUST BE REMOVED AND REPLACED WITH MATERIAL HAVING AN INFILTRATION RATE COMPARABLE WITH THE POORLY-GRADED SAND LOCATED AT THE BOTTOM OF THE SYSTEM.


SEDIMENT FROM EXCAVATED BASIN PRIOR TO PLACEMENT OF FILTER MEDIA. PLACE SAND BAGS OR SIMILAR ITEM IN CURB CUTS TO PRE-FILTER STORM WATER UNTIL PLANTS ARE ESTABLISHED IN BASINS. MAINTAIN INLET PROTECTION ON DOWN STREAM INLETS UNTIL

2. BASIN EXCAVATION SHALL BE WITH TOOTHED-BUCKETS TO SCARIFY THE BOTTOM.

3. PLACE SILT FENCE AROUND BASINS AS SHOWN IMMEDIATELY AFTER BASIN CONSTRUCTION. 4. BASINS MUST BE TESTED FOR INFILTRATION RATE AFTER TOTAL SITE STABILIZATION. A DUAL RING INFILTROMETER SHALL BE USED FOR TESTING. MINIMUM INFILTRATION RATE IS 1-INCH PER HOUR. IF BASIN DOES NOT MEET INFILTRATION RATE, CONTRACTOR MUST TAKE CORRECTIVE ACTION UNTIL MINIMUM INFILTRATION RATE IS MET. CORRECTIVE ACTION MAY INCLUDE REMOVING PLUG IN DRAIN TILE. ALL TESTING AND CORRECTIVE ACTION SHALL BE THE RESPONSIBILITY OF THE CONTRACTOR, AND SHALL BE INCIDENTAL TO THE CONTRACT, WITH NO DIRECT COMPENSATION MADE.

1" = 10' 10' 20' NOT FOR CONSTRUCTION

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NUM	Westwood		I HEREBY CERTIFY THAT THIS PLAN WAS PREPARED BY ME OR UNDER MY DIRECT SUPERVISION AND THAT I AM A	PREPARED FOR:	INITIAL ISSUE: 11/16/2020 REVISIONS:	DESIGNED:	
			DULY LICENSED PROFESSIONAL ENGINEER UNDER THE LAWS OF THE STATE OF MINNESOTA		▲ 01/25/2021 US BANK FINAL DEVELOPMENT PLANS	CHECKED:	·I
GRADING PLAN	Phone (952) 937-5150 12701 Whitewater Drive, Suite #300 Fax (952) 937-5822 Minnetonka, MN 55343	US BANK - EDINA		RSP ARCHITECTS	▲ 02/26/2021 WATERSHED COMMENTS	DRAWN: .	J
	Toll Free (888) 937-5150 westwoodps.com		DAVID T. BADE		△ 06/04/2021 CITY OF EDINA SITE UPDATE	HORIZONTAL SCALE: 10'	-
	Westwood Professional Services, Inc.	EDINA, MN	DATE: 02/26/2021 LICENSE NO.	MINNEAPOLIS, MN 55413		VERTICAL SCALE: 2' or 1'	_
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- 1. THE CONTRACTOR IS SPECIFICALLY CAUTIONED THAT THE LOCATION AND/OR ELEVATION OF EXISTING 7. WATER MAIN LENGTHS AS SHOWN ARE APPROXIMATE HORIZONTAL LENGTHS. ALLOW FOR UTILITIES AS SHOWN ON THESE PLANS ARE BASED ON RECORDS OF THE VARIOUS UTILITY COMPANIES AND LIMITED MEASUREMENTS TAKEN IN THE FIELD. THE INFORMATION SHALL NOT BE RELIED ON AS BEING EXACT OR COMPLETE. THE CONTRACTOR SHALL VERIFY EXISTING CONDITIONS PRIOR TO CONSTRUCTION AND NOTIFY THE OWNER OR ENGINEER OF DISCREPANCIES.
- ALL SANITARY SEWER, STORM SEWER AND WATER MAIN MATERIAL AND INSTALLATIONS SHALL BE PER 8. PROVIDE WATER MAIN THRUST RESTRAINTS PER CITY STANDARD REQUIREMENTS. CITY REQUIREMENTS, MINNESOTA PLUMBING CODE, AND IN ACCORDANCE WITH THE CURRENT EDITION OF "STANDARD SPECIFICATIONS FOR WATER MAIN AND SERVICE LINE INSTALLATION AND SANITARY SEWER AND STORM SEWER INSTALLATION" AS PREPARED BY THE CITY ENGINEERS ASSOCIATION OF MINNESOTA.
- 3. PRIOR TO CONSTRUCTION, THE CONTRACTOR SHALL OBTAIN THE NECESSARY FEDERAL, STATE AND LOCAL PERMITS FOR THE PROPOSED WORK OR VERIFY WITH THE OWNER OR ENGINEER THAT PERMITS HAVE BEEN OBTAINED. PERMIT FEES SHALL BE THE RESPONSIBILITY OF THE CONTRACTOR UNLESS OTHERWISE ARRANGED WITH THE OWNER.
- 4. CONTRACTOR SHALL REFER TO ARCHITECTURAL PLANS FOR EXACT LOCATION AND DIMENSIONS OF DOORWAYS, RAMPS, TRUCK DOCKS, PRECISE BUILDING DIMENSIONS AND EXACT BUILDING UTILITY CONNECTION LOCATIONS.
- 5. ALL PRIVATE UTILITIES SHALL BE CONSTRUCTED IN ACCORDANCE WITH THE SPECIFICATIONS OF THE APPROPRIATE UTILITY COMPANY. THE CONTRACTOR SHALL COORDINATE THE SERVICE LINE CONSTRUCTION WITH THE UTILITY COMPANIES.
- 6. CONTRACTOR SHALL OBTAIN ALL NECESSARY CITY PERMITS FOR UTILITY CONNECTIONS, AND UTILITIES SHALL BE INSPECTED AND APPROVED BY THE CITY. THE CITY SHALL BE NOTIFIED 48-HOURS PRIOR TO COMMENCING WITH THE UTILITY CONSTRUCTION OR ANY REQUIRED TESTING. CONTRACTOR SHALL NOT OPERATE, INTERFERE WITH, CONNECT ANY PIPE OR HOSE TO, OR TAP ANY WATER MAIN BELONGING TO THE CITY UNLESS DULY AUTHORIZED TO DO SO BY THE CITY. ANY ADVERSE CONSEQUENCES OF SCHEDULED OR UNSCHEDULED DISRUPTIONS OF SERVICE TO THE PUBLIC ARE TO BE THE RESPONSIBILITY OF THE CONTRACTOR.

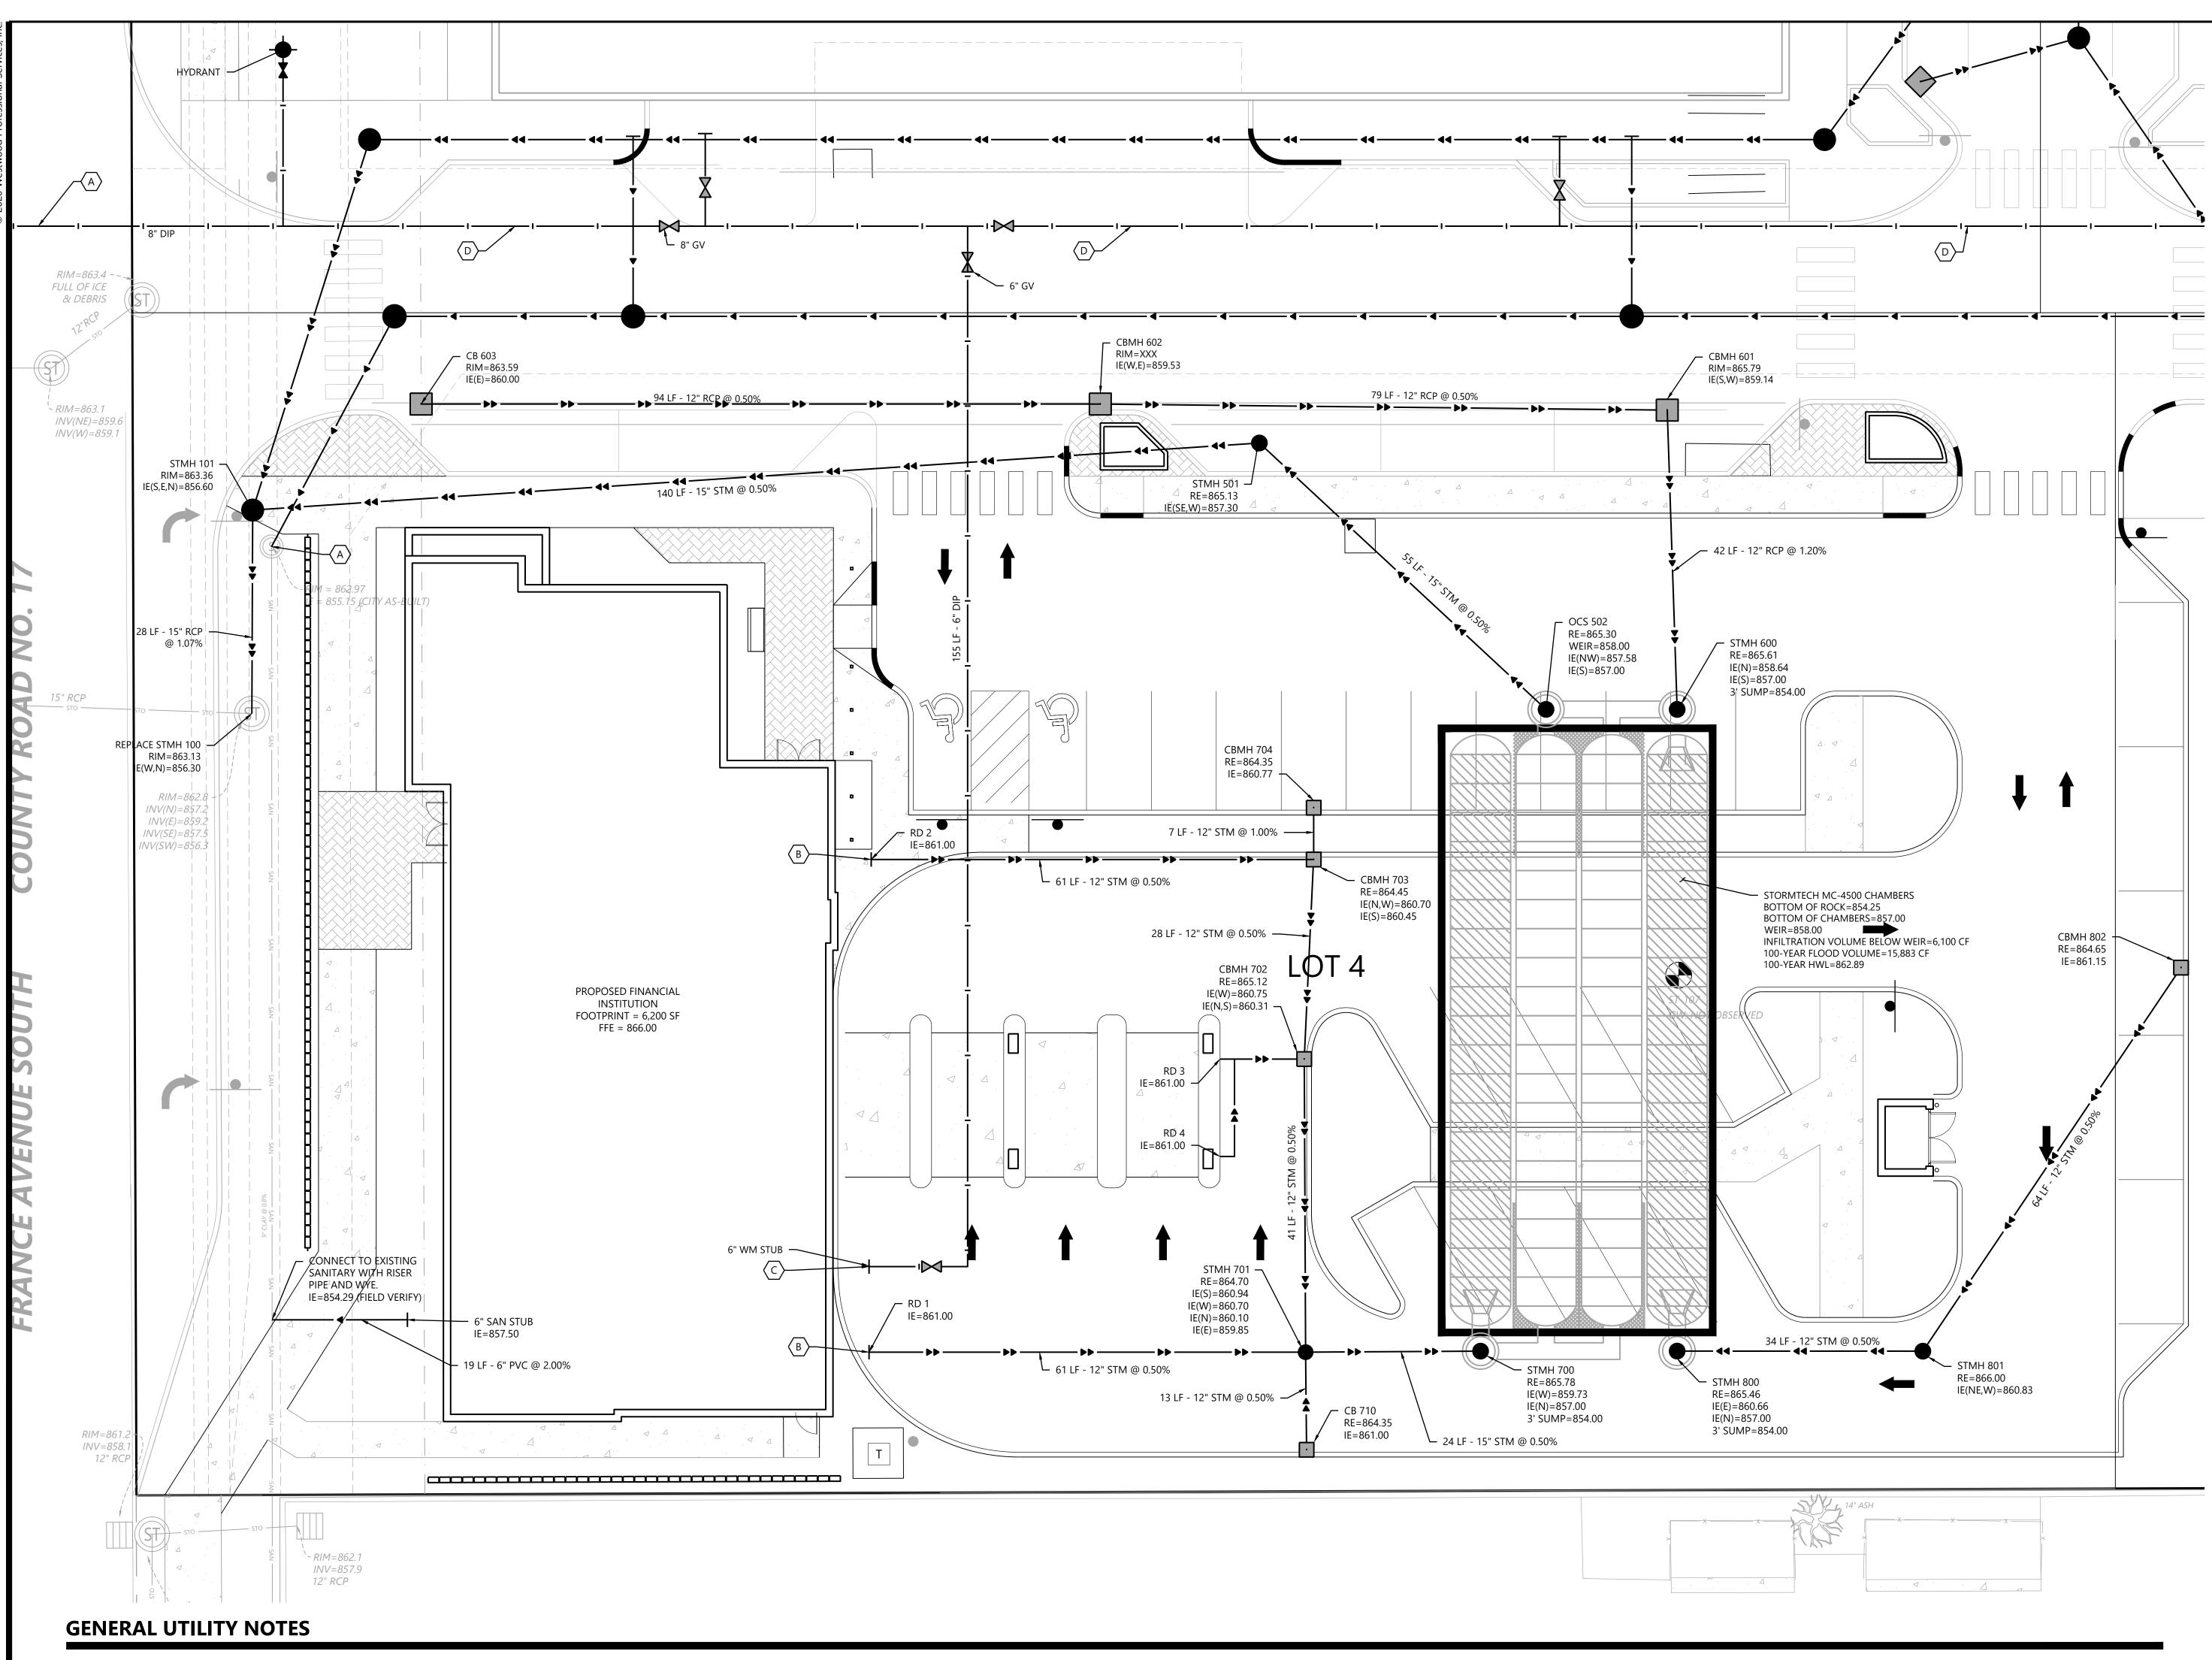- LOCAL GOVERNING SPECIFICATIONS. FITTINGS REQUIRED TO CONSTRUCT WATER MAIN SHALL BE INCLUDED IN WATER MAIN CONSTRUCTION.
- 9. A MINIMUM VERTICAL SEPARATION OF 18 INCHES IS REQUIRED AT ALL WATER LINE CROSSINGS WITH SANITARY SEWER OR STORM SEWER. THE WATER LINE SHALL NOT HAVE JOINTS OR CONNECTION WITHIN 10-FEET OF THE CROSSING. INSULATE CROSSINGS WITH STORM SEWER.
- NOTED.
- 11. DUCTILE IRON WATER LINES SHALL BE CLASS 52, PER AWWA C115 OR C151. COPPER WATER LINES AWWA C605 IF ALLOWED BY CITY.
- BE TESTED ACCORDING TO MINNESOTA PLUMBING CODE, PART 712.0.

ADDITIONAL PIPE WHEN INSTALLING ON SLOPES OR WHEN DEFLECTIONS ARE REQUIRED. THE JOINT DEFLECTIONS SHALL NOT EXCEED THE MAXIMUM RECOMMENDED BY THE PIPE MANUFACTURER OR BY

10. UTILITY SERVICES TYPICALLY TERMINATE 5' OUTSIDE BUILDING WALL UNLESS OTHERWISE SHOWN OR

SHALL BE TYPE K PER ASTM B88. PVC WATER LINES SHALL BE PER AWWA C900 AND INSTALLED PER

12. ALL WATER LINES SHALL HAVE 8' MINIMUM COVER. INSULATE WATER MAIN IF LESS THAN 8' OF COVER. INSULATION SHALL BE DOW STYROFOAM HI BRAND 35 OR EQUIVALENT, WITH 4 INCHES OF THICKNESS.

13. SANITARY SEWER PIPE OUTSIDE THE BUILDING ENVELOPE SHALL BE POLYVINYL CHLORIDE (PVC) SDR 35 OR 26. SDR 26 IS REQUIRED FOR DEPTHS GREATER THAN 15 FEET. SANITARY SEWER PIPE WITHIN 5 FEET OF THE BUILDING AND UNDER FOOTINGS SHALL BE SCHEDULE 40 PER ASTM D2665. ALL PLASTIC SANITARY SEWER SHALL BE INSTALLED PER D2321. SOLVENT WELD JOINTS MUST INCLUDE USE OF A PRIMER WHICH IS OF A CONTRASTING COLOR TO THE PIPE AND CEMENT. ALL SANITARY SEWER SHALL

14. STORM SEWER PIPE:

- A. RCP AND HDPE PIPE MAY BE INSTALLED WITH APPROVAL OF LOCAL GOVERNING AGENCY. B. REINFORCED CONCRETE PIPE SHALL BE CLASS 5 FOR PIPE DIAMETERS 18" AND SMALLER, CLASS 3 FOR PIPE DIAMETERS 21" AND LARGER UNLESS OTHERWISE NOTED, PER ASTM C76 WITH R-4
- GASKETS. C. HDPE STORM PIPE 4- TO 10-INCHES IN DIAMETER SHALL MEET REQUIREMENTS OF AASHTO M252. HDPE STORM PIPE 12- TO 60-INCHES IN DIAMETER SHALL MEET REQUIREMENTS OF ASTM F2306. FITTINGS SHALL BE PER ASTM D3212 AND INSTALLED PER ASTM D2321.
- D. PVC STORM SEWER PIPE AND FITTINGS SHALL BE SCHEDULE 40 PIPE PER ASTM D2665 AND INSTALLED PER ASTM D2321.
- E. CORRUGATED METAL PIPE (CMP) FOR SIZES 18- TO 120-INCH AND MUST MEET ASTM A760 OR ASTM A796 AND BE INSTALLED PER ASTM A798. CMP MAY NOT BE INSTALLED WITHIN 10-FEET OF A WATERMAIN, WATER SERVICE, OR A BUILDING.
- F. ALL STORM SEWER JOINTS AND STRUCTURE CONNECTIONS SHALL BE GASTIGHT OR WATERTIGHT AS REQUIRED BY MINNESOTA PLUMBING CODE, PART 707.3. STORM SEWER LOCATED WITHIN 10-FEET OF A BUILDING AND/OR WATER LINE SHALL BE TESTED PER MINNESOTA PLUMBING CODE, PART 712.
- 15. ALL NONCONDUCTIVE PIPE SHALL BE INSTALLED WITH A LOCATE (TRACER) WIRE PER MINNESOTA RULES, PART 7560.0150.

16. POST INDICATOR VALVES SHALL BE CLOW F-5750 (OR EQUIVALENT) MEETING AWWA STANDARD C509 AND CITY STANDARDS. VALVE TO BE MECHANICAL JOINT RESILIENT WEDGE GATE VALVE. POST TO BE ADJUSTABLE FOR 8 FEET WATER MAIN DEPTH. THE ELECTRICAL ALARM SWITCH SHALL BE PART NO. PCVS2 (OR EQUIVALENT).

- REFLECT THE SUMPED ELEVATIONS.

17. AFTER CONSTRUCTION IS COMPLETED, THE CONTRACTOR SHALL PROVIDE THE OWNER WITH AN AS-BUILT RECORD OF UTILITY CONSTRUCTION. THE AS-BUILT SHALL INCLUDE LOCATION AND LENGTH DEVIATIONS OR CHANGES TO THE PLAN. CONTRACTOR TO VERIFY WITH OWNER OR ENGINEER WHETHER A PLAN WITH POST-CONSTRUCTION ELEVATIONS IS REQUIRED.

18. ALL MANHOLE CASTINGS IN PAVED AREAS SHALL BE SUMPED 0.05 FEET. RIM ELEVATIONS ON PLAN


19. ALL CATCH BASIN CASTINGS IN CURB SHALL BE SUMPED 0.15 FEET AND MANHOLE CASTINGS IN PAVED AREAS SHALL BE SUMPED 0.05 FEET. RIM ELEVATIONS ON PLAN REFLECT THE SUMPED ELEVATIONS.

UTILITY LEGEND


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STO		>>	STORM SEWER
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WAT		I••¢	HYDRANT
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PUG		PUG	UNDERGROUND ELECTRIC
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\land UTILITY KEYNOTE

CONNECT TO EXISTING. COORDINATE CONNECTION WITH THE CITY. REVIEW AND COORDINATE FINAL ROOF DRAIN LOCATIONS WITH PLUMBING PLAN. COMBINED FIRE/DOMESTIC WITH INTERNAL SPLIT. SEE PLUMBING PLAN. PHASED WATERMAIN CONSTRUCTION AS PART OF OVERALL SITE REDEVELOPMENT TO SERVE NEW US BANK BUILDING. UTILITY PHASING PLAN TO BE DEVELOPED BY MORTENSON.



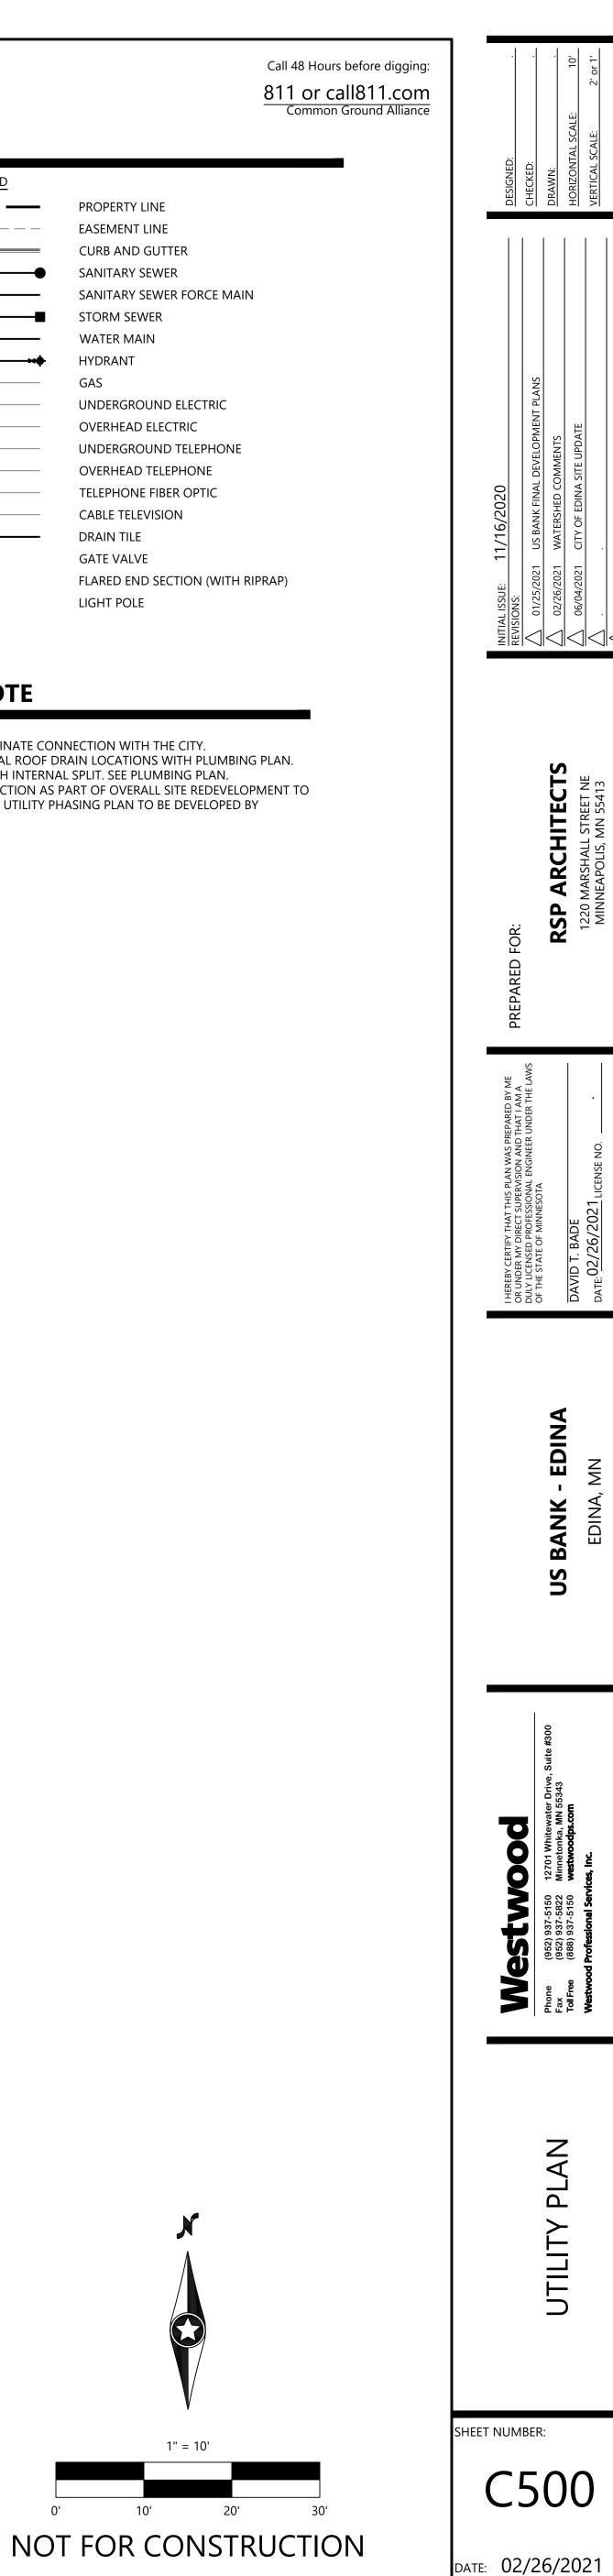


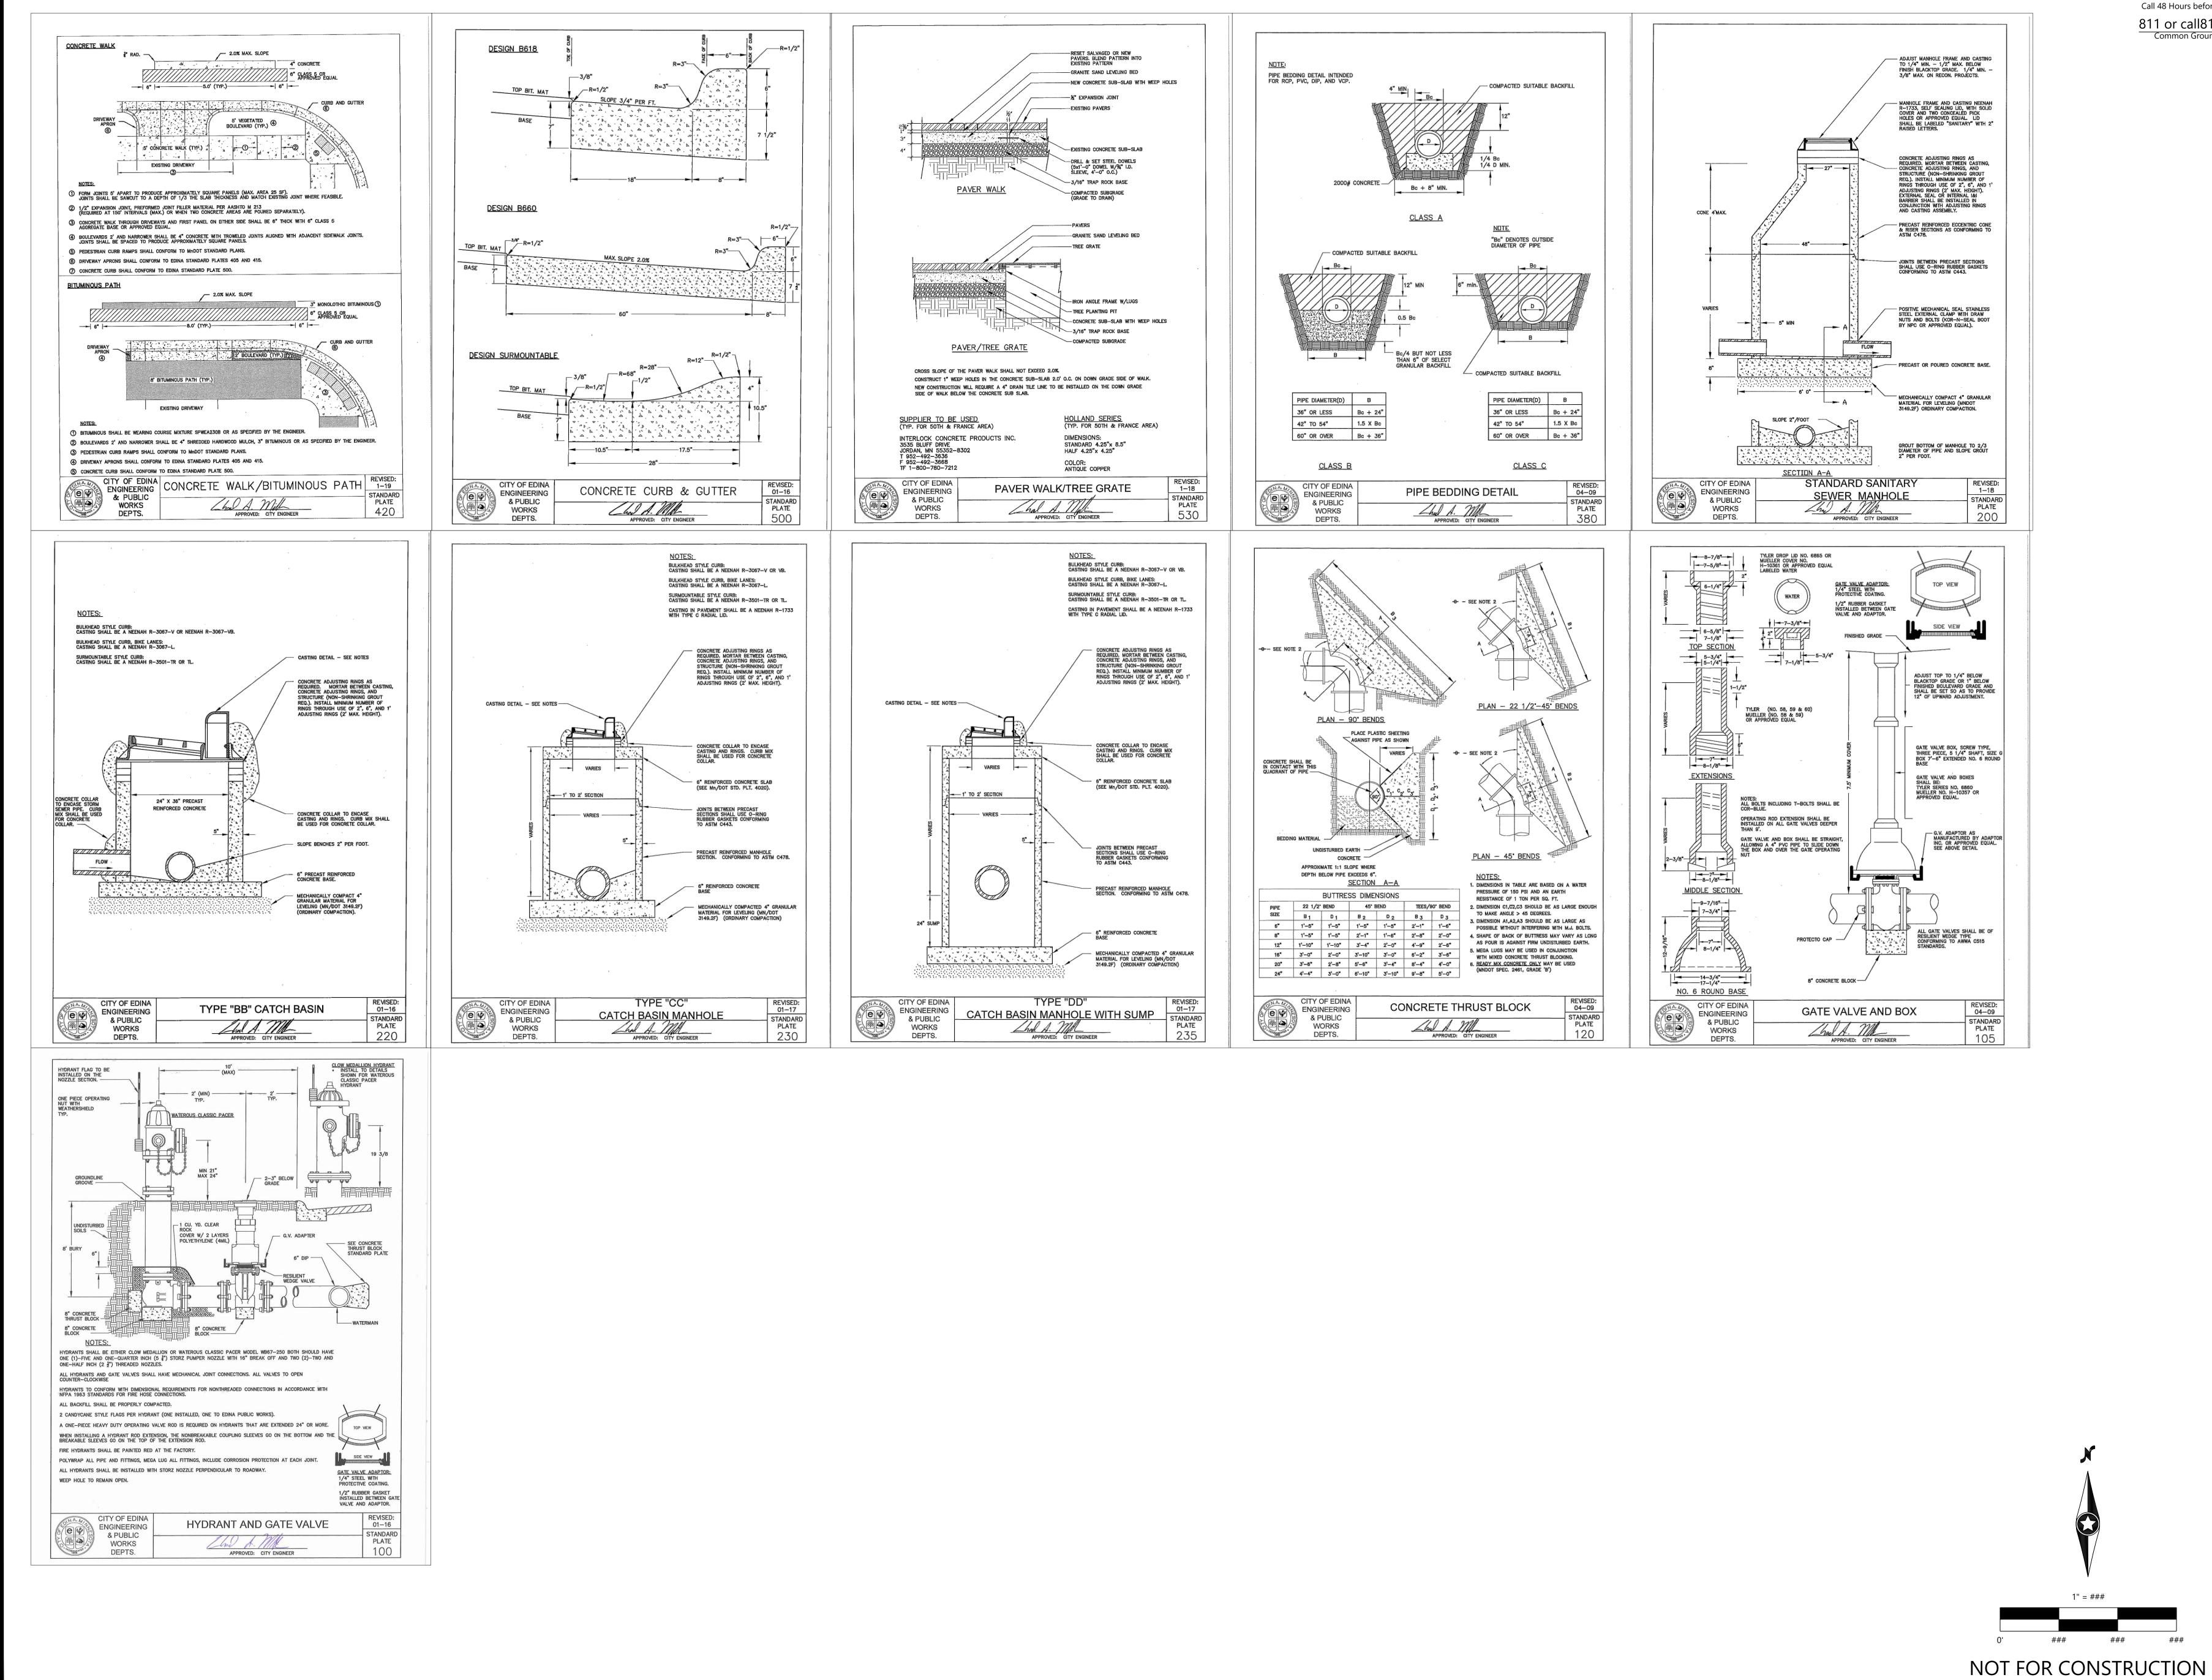


Phone(952) 937-515012701 Whitewater Drive, Suite #300Phone(952) 937-515012701 Whitewater Drive, Suite #300Fax(952) 937-5150Minnetonka, MN 55343Toll Free(888) 937-5150westwoodps.comWestwood Professional Services, Inc.


Call 48 Hours before digging 811 or call811.com Common Ground Alliance

2020 Westwood Professional Services,

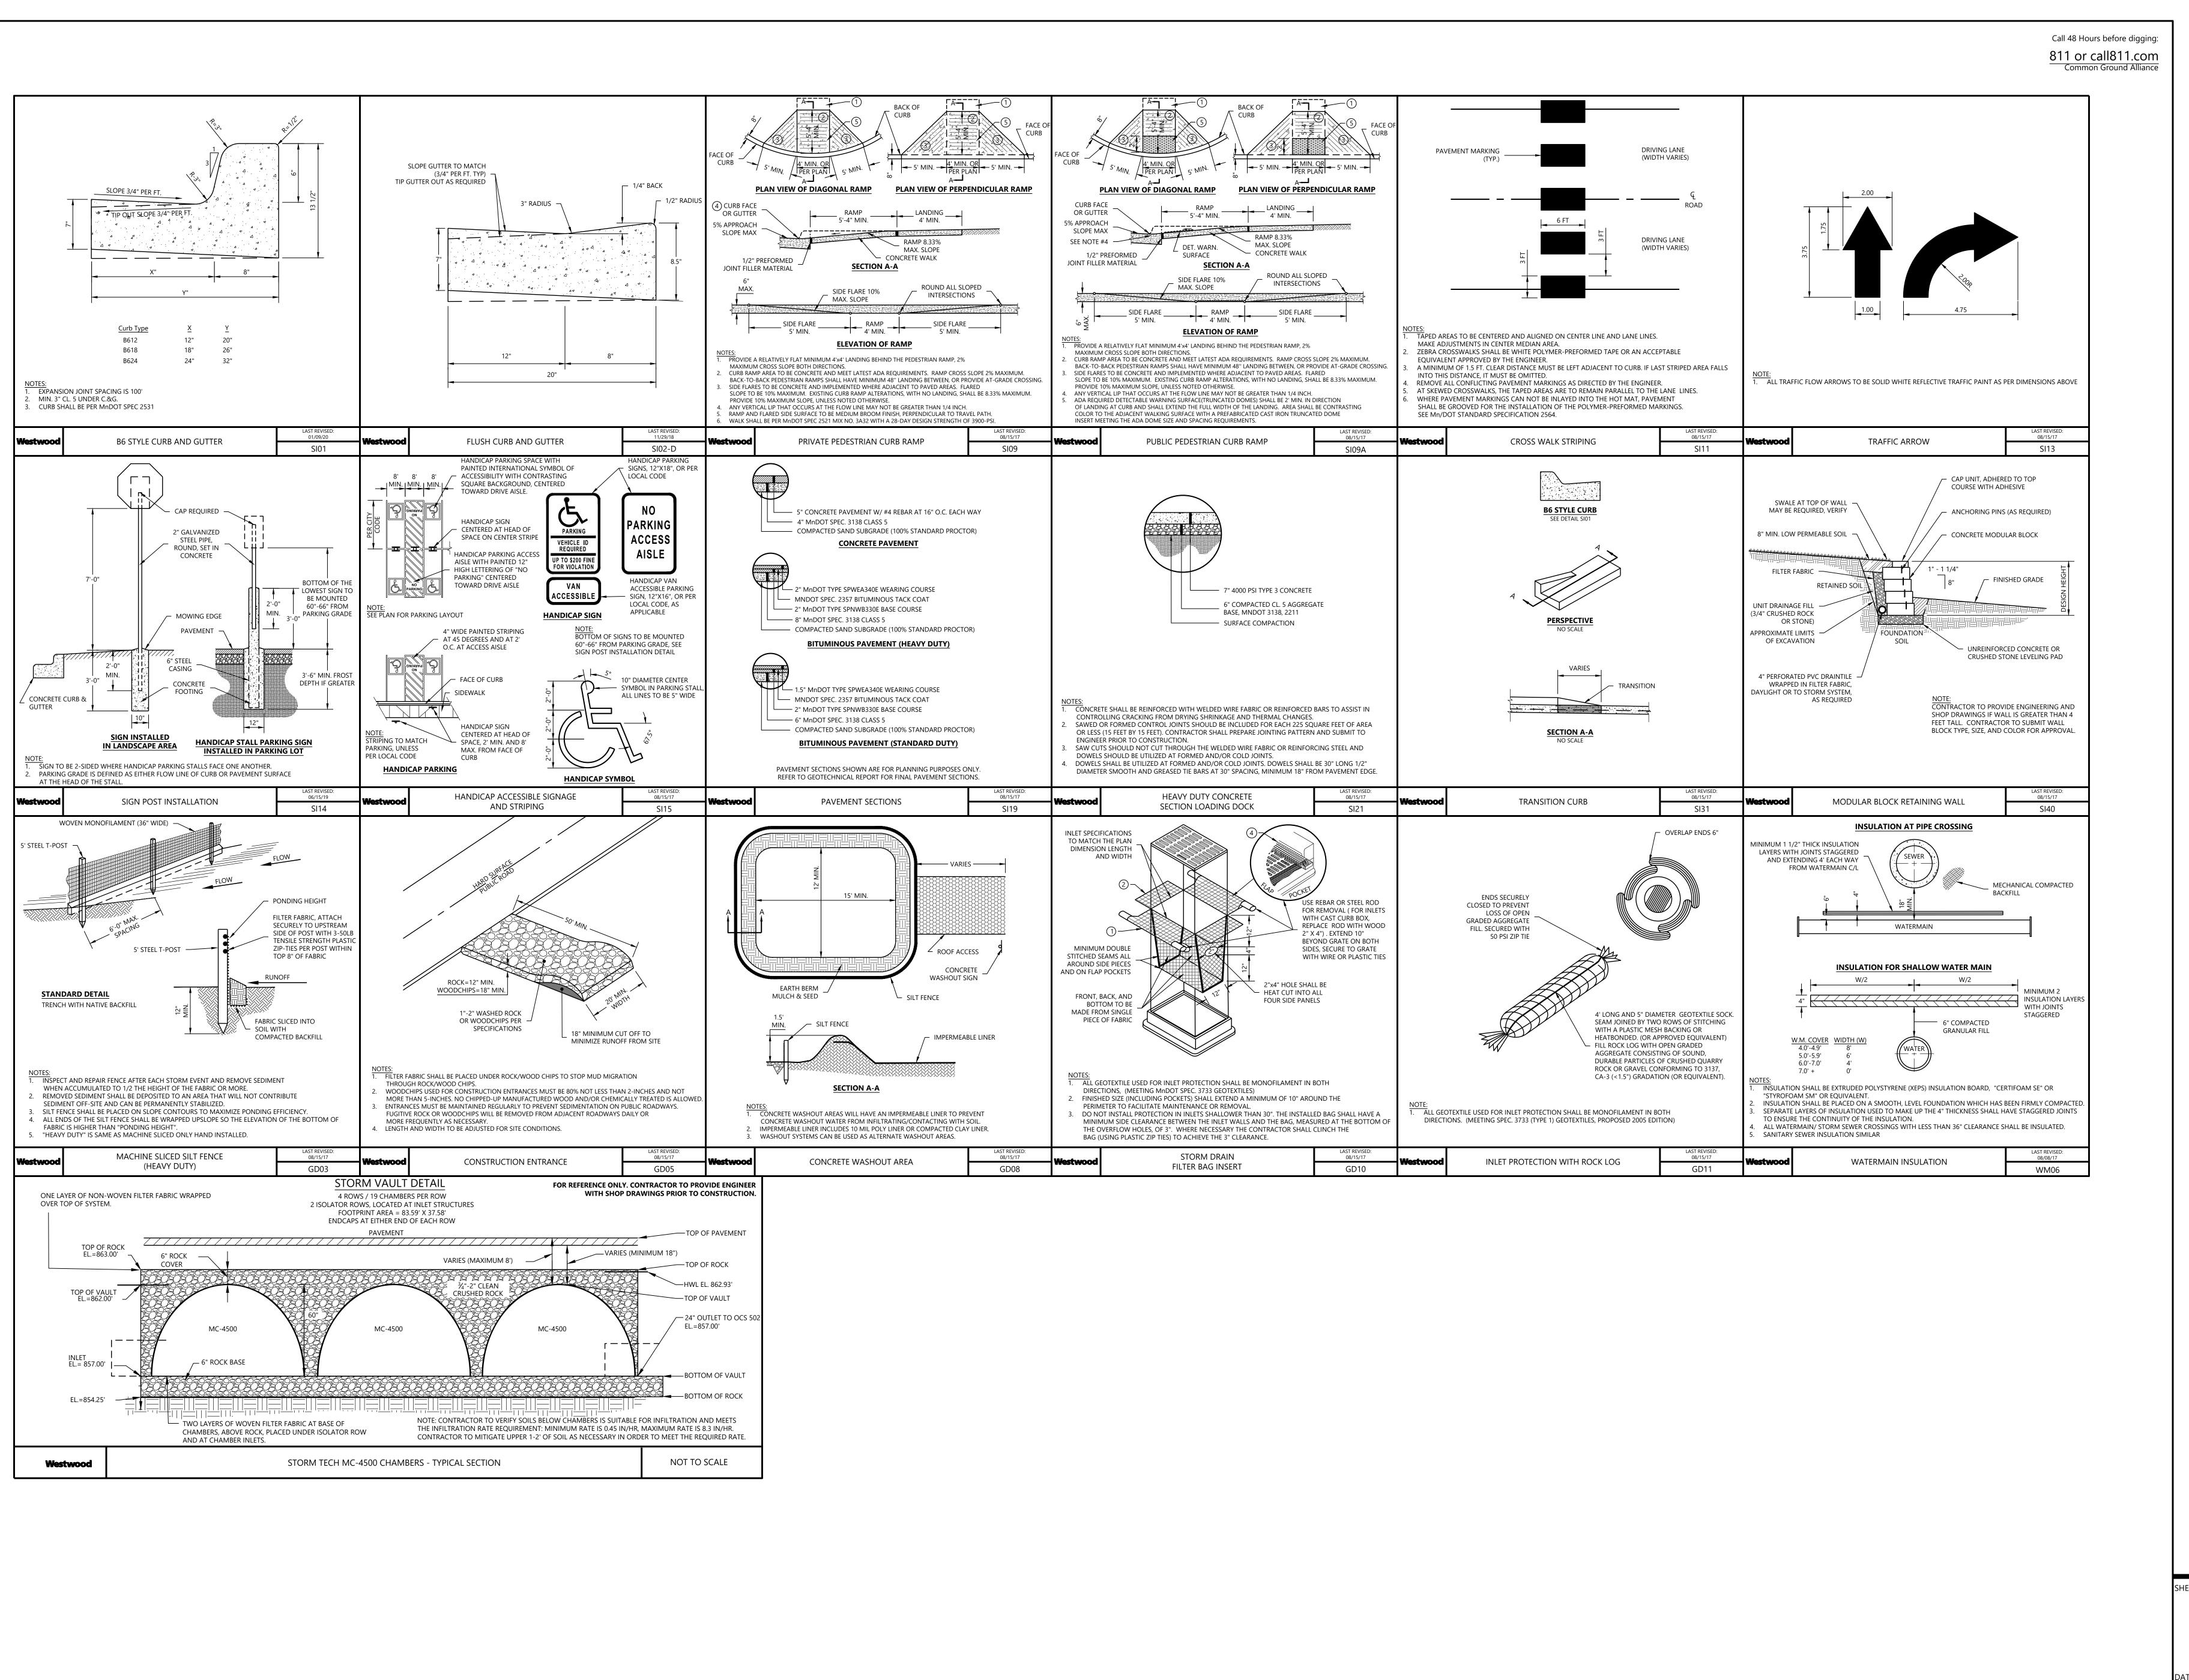


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Г NUMB С7		Westwood		I HEREBY CERTIFY THAT THIS PLAN WAS PREPARED BY ME OR UNDER MY DIRECT SUPERVISION AND THAT I AM A DI ITY LICENEED PROFESSIONAL ENGINEER LINDER THELAWS	PREPARED FOR:	INITIAL ISSUE: 11/16/2020 Revisions:	DESIGNED:
7C	DETAILS	Phone (952) 937-5150 12701 Whitewater Drive, Suite #300 Fax (952) 937-5822 Minnetonka, MN 55343	US BANK - FDINA	OF THE STATE OF MINNESOTA	RSP ARCHITECTS	▲ 01/25/2021 US BANK FINAL DEVELOPMENT PLANS ▲ 02/26/2021 WATERSHED COMMENTS	DRAWN:
-	J	ree wood F	EDINA, MN	DAVID T. BADE DATE: 02/26/2021 LICENSE NO.	1220 MARSHALL STREET NE MINNEAPOLIS MN 55413	▲ 06/04/2021 CITY OF EDINA SITE UPDATE	HORIZONTAL SCALE: ### VERTICAL SCALE: ### or ##

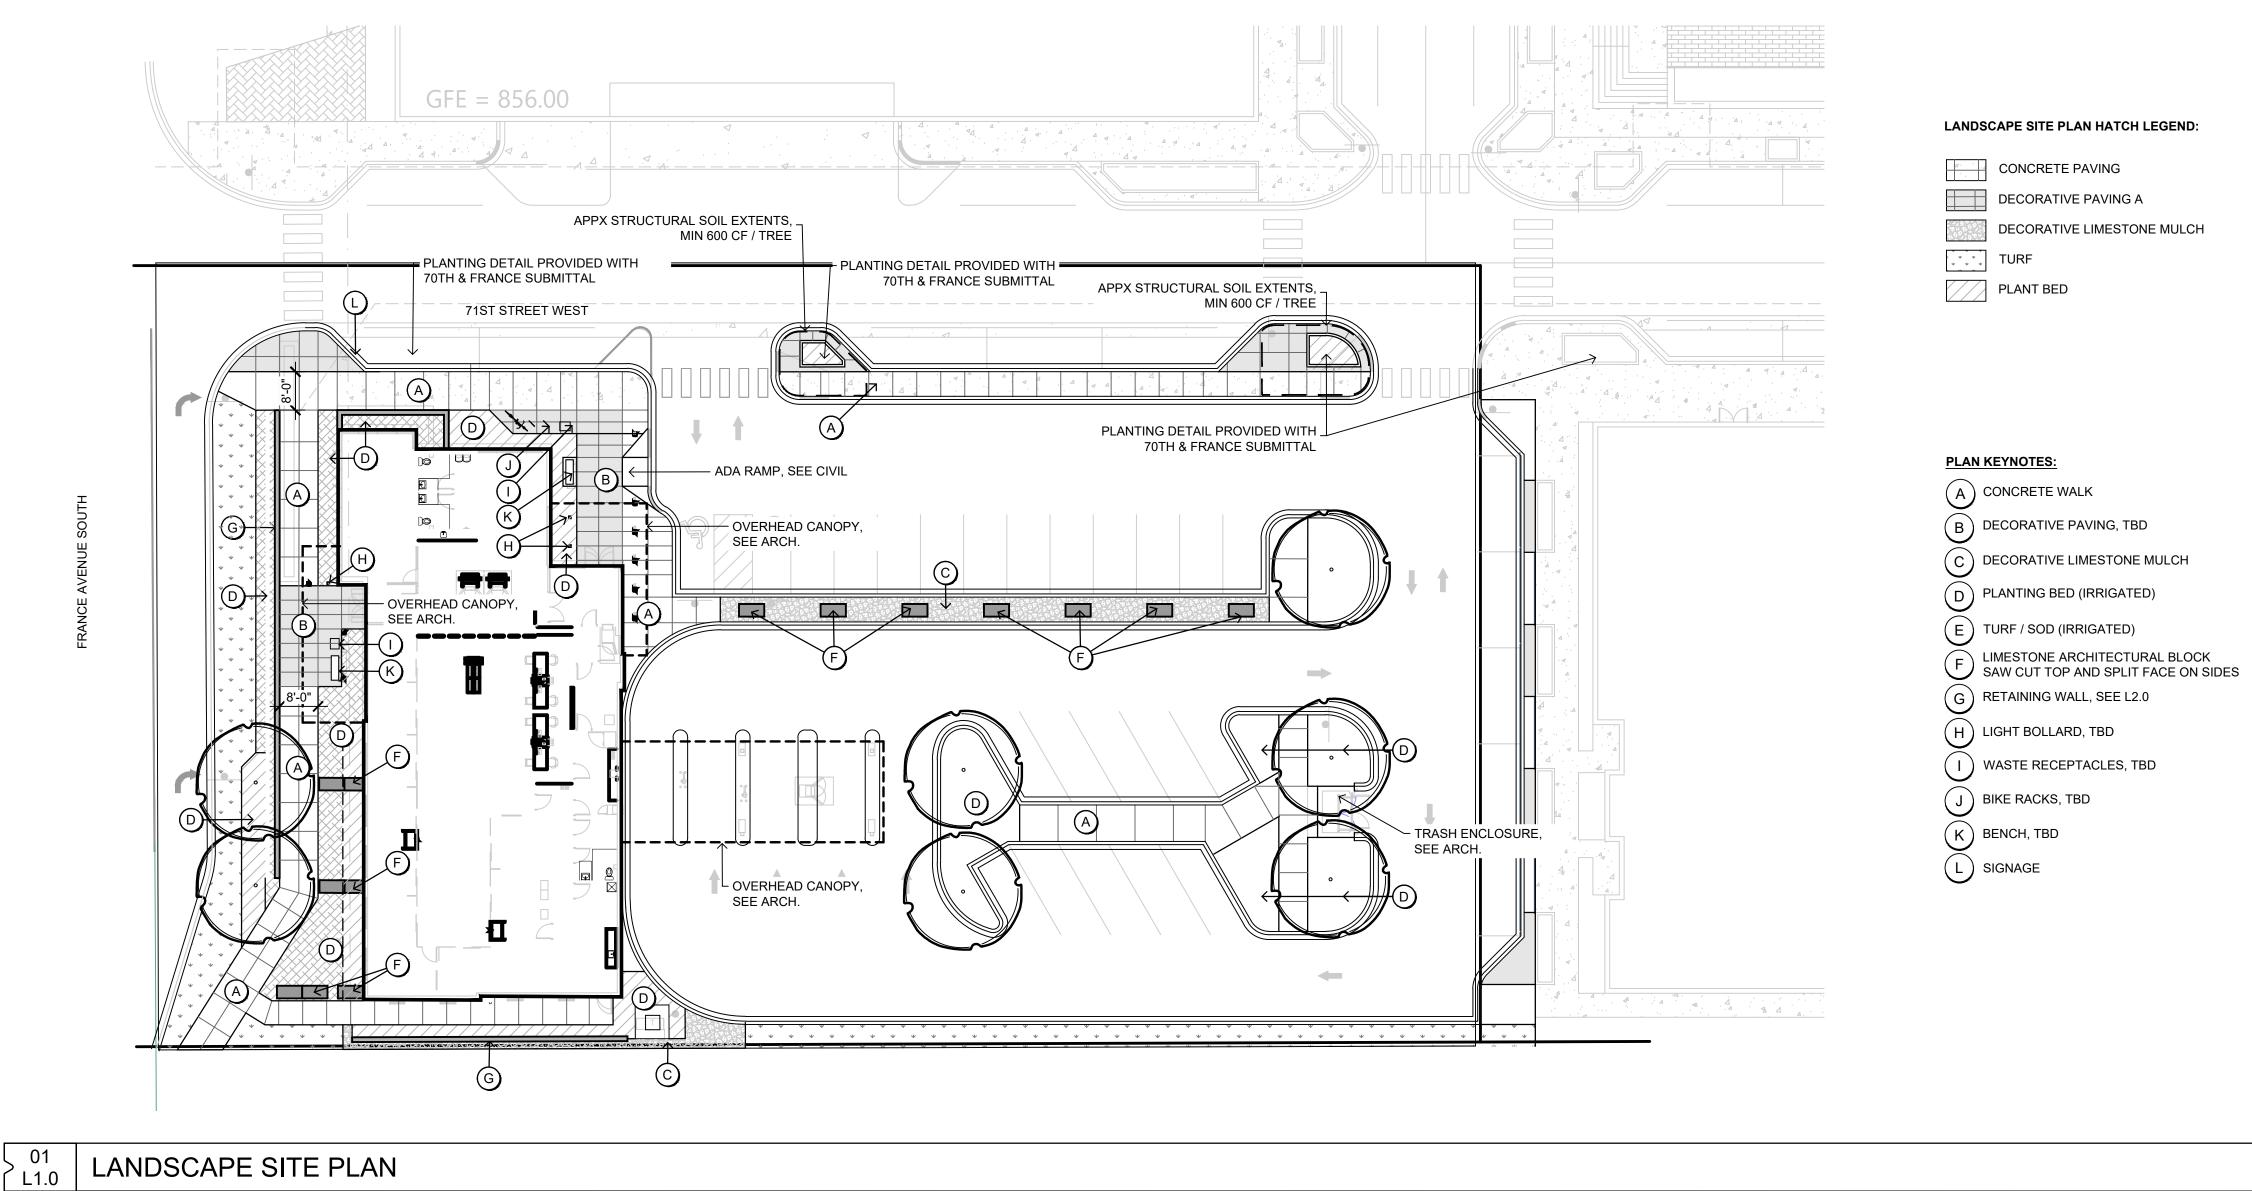

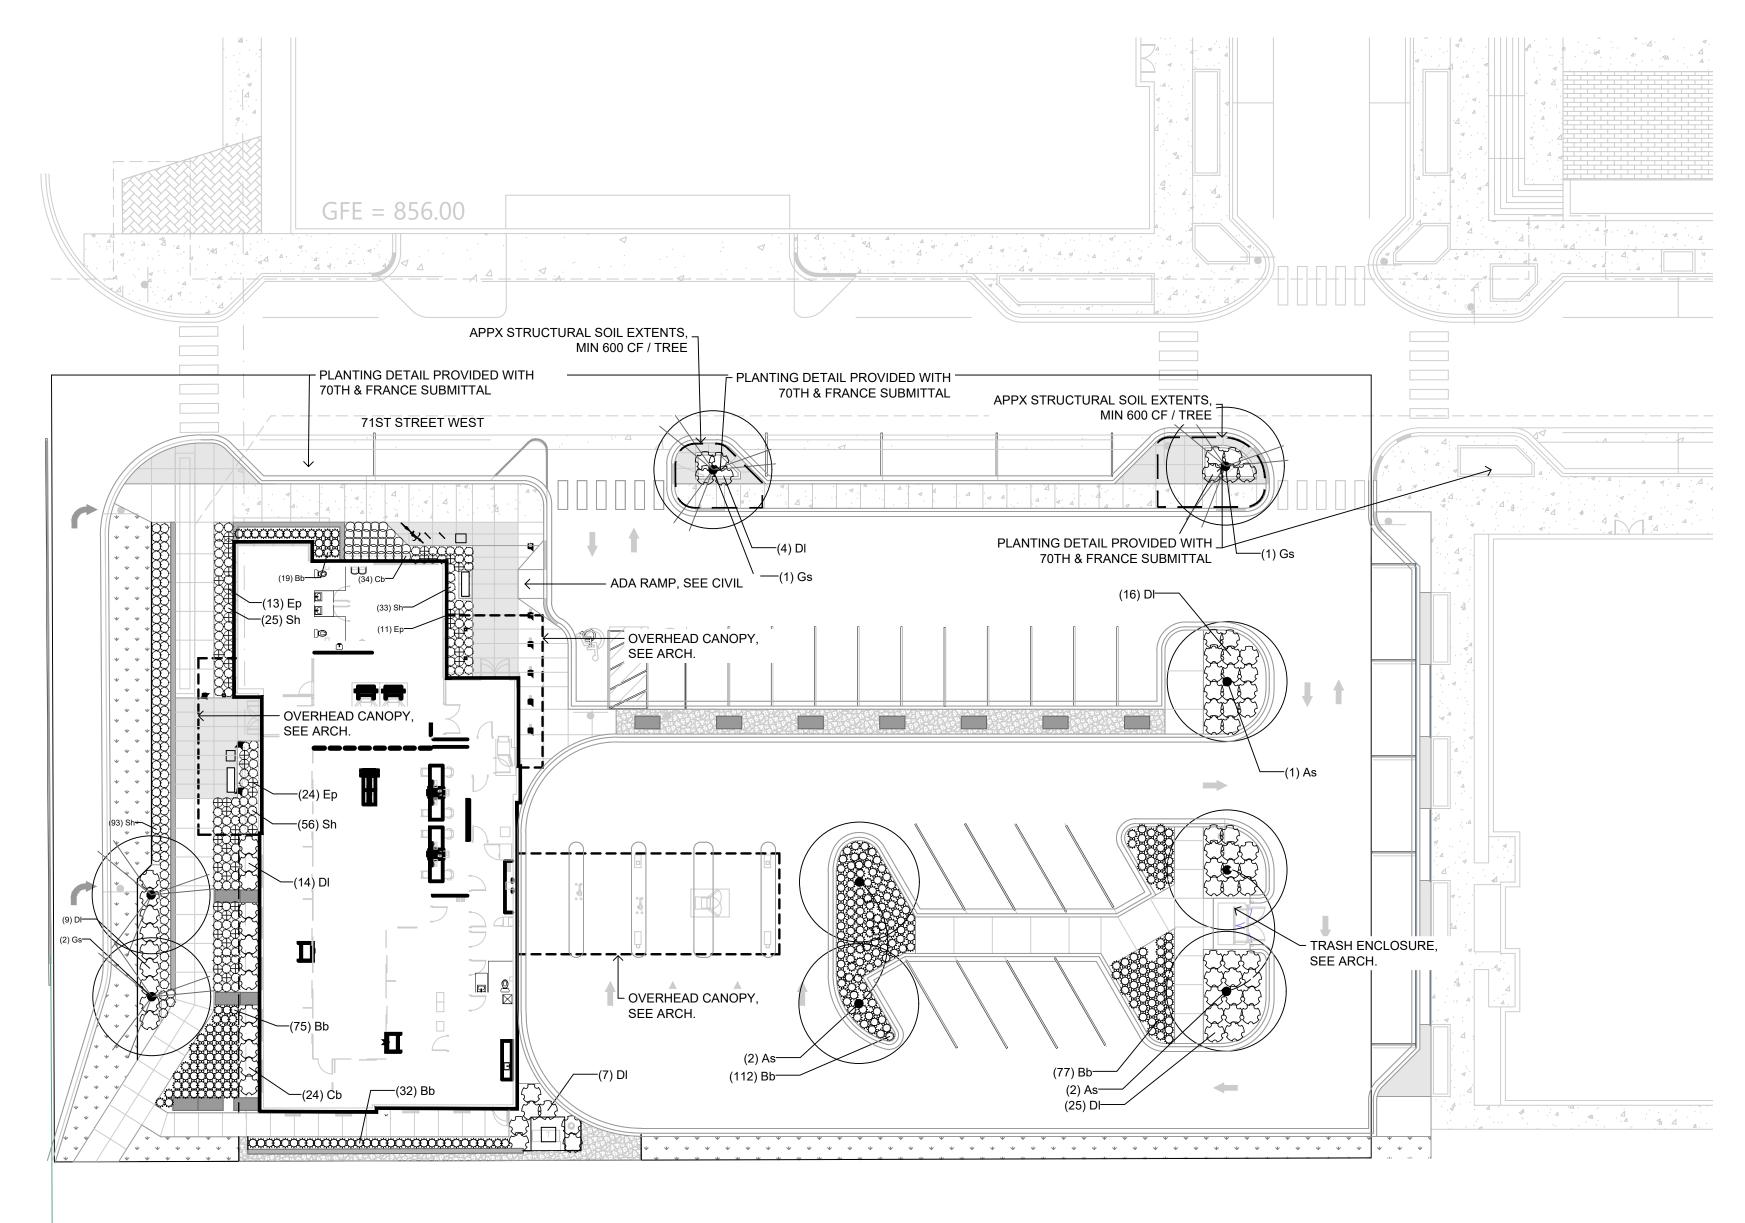


 $\begin{array}{|c|c|} & & 02 \\ & L1.0 \end{array}$

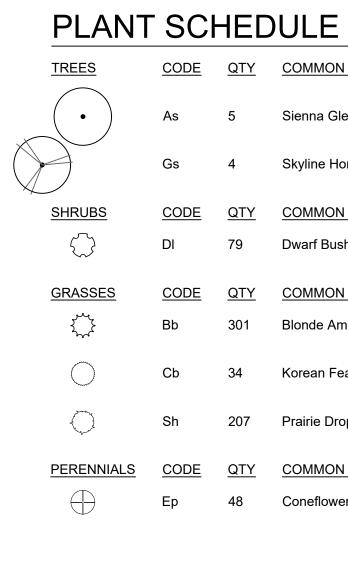



SCALE:1"=20' 0' 10' 20' \bigcirc

<u>QTY</u>	COMMON / BOTANICAL NAME	<u>CONT</u>	CAL
5	Sienna Glen Maple / Acer x freemanii `Sienna` TM	B & B	2.5"Cal
4	Skyline Honey Locust / Gleditsia triacanthos `Skyline`	B & B	2.5"Cal
<u>QTY</u>	COMMON / BOTANICAL NAME	CONT	
79	Dwarf Bush Honeysuckle / Diervilla lonicera	5 gal	
<u>QTY</u>	COMMON / BOTANICAL NAME	<u>CONT</u>	
301	Blonde Ambition Blue Grama / Bouteloua gracilis `Blonde Ambition`	1 gal	
34	Korean Feather Reed Grass / Calamagrostis brachytricha	1 gal	
207	Prairie Dropseed / Sporobolus heterolepis	5 gal	
<u>QTY</u>	COMMON / BOTANICAL NAME	<u>CONT</u>	
48	Coneflower / Echinacea purpurea	5 gal	


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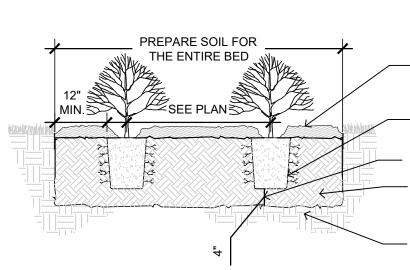


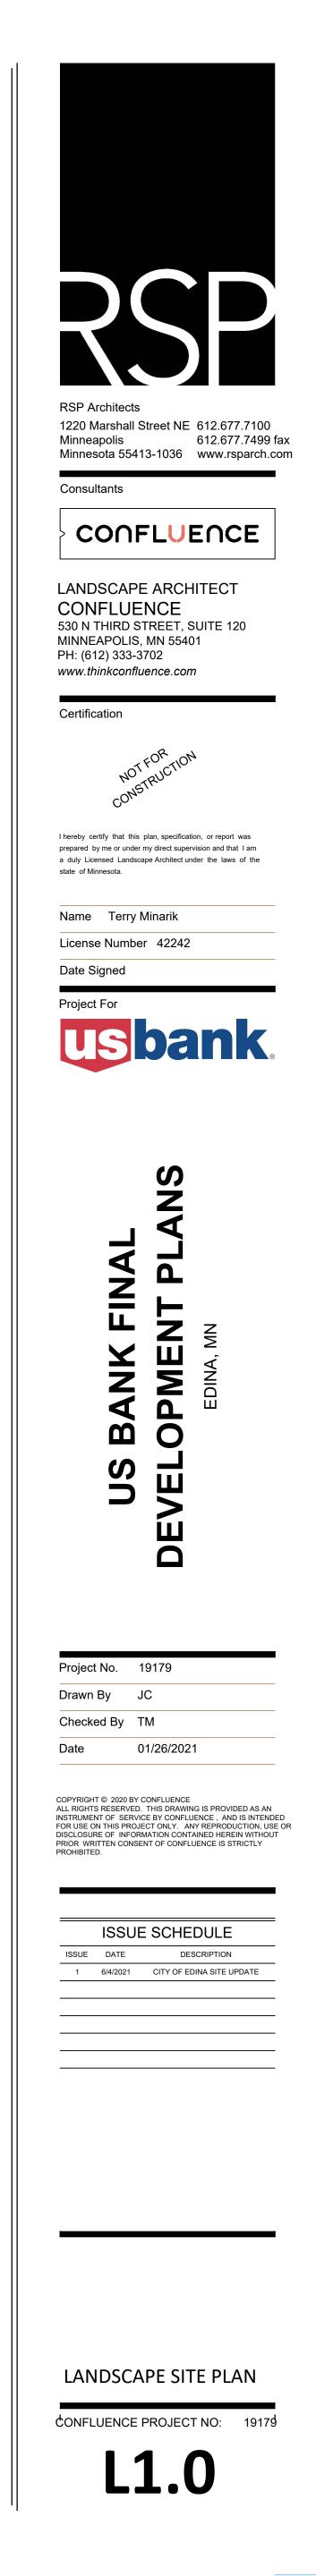

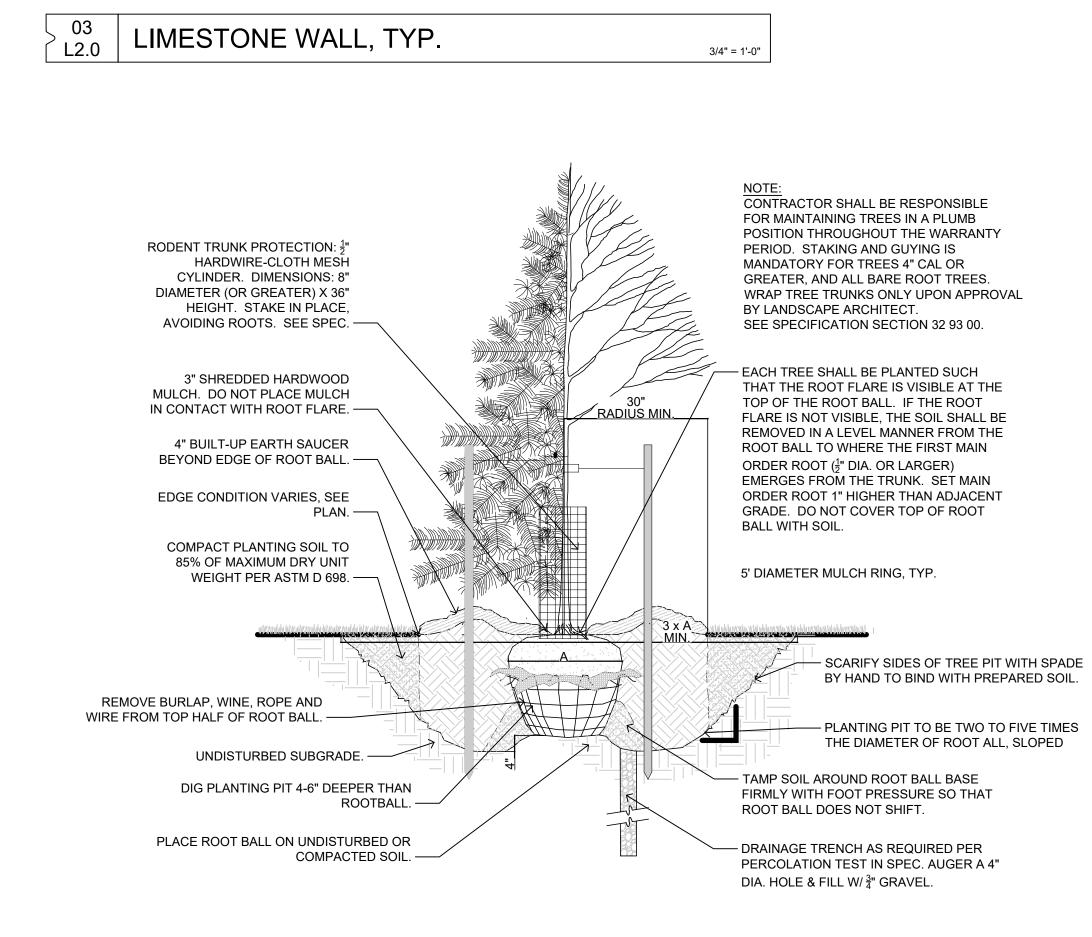NOTES:

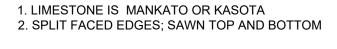

 $\begin{array}{|c|c|} & 01 \\ L2.0 \end{array}$ TREE PLANTING DETAIL, TYP.

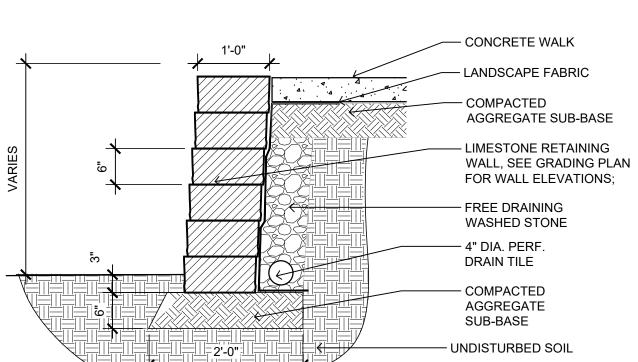



NOTE: SEE SPECIFICATION SECTION RELATED TO EXTERIOR PLANTING.
3" SHREDDED HARDWOOD MULCH. DO NOT PLACE MULCH IN CONTACT WITH SHRUB STEM.
CONTAINER GROWN MATERIAL SHALL HAVE ROOTS HAND LOOSENED.
MIN.4" DEEPER THAN ROOT BALL.
SCARIFY SIDES AND BOTTOM OF ENTIRE BED WITH SPADE BY HAND TO BIND WITH PLANTING SOIL.
UNDISTURBED SUBGRADE.


 $\begin{array}{|c|c|} & 01 \\ L2.0 \end{array}$ PLANTING DETAIL, TYP.


1/2" = 1'-0"


1/2" = 1'-0"

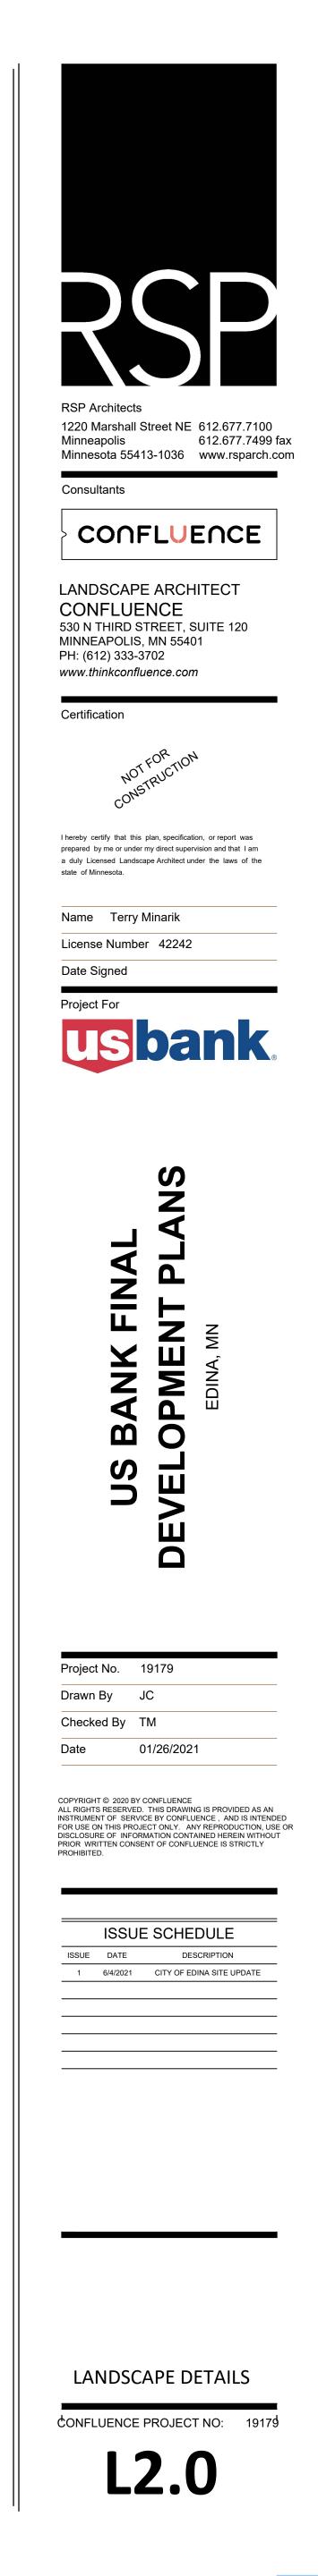

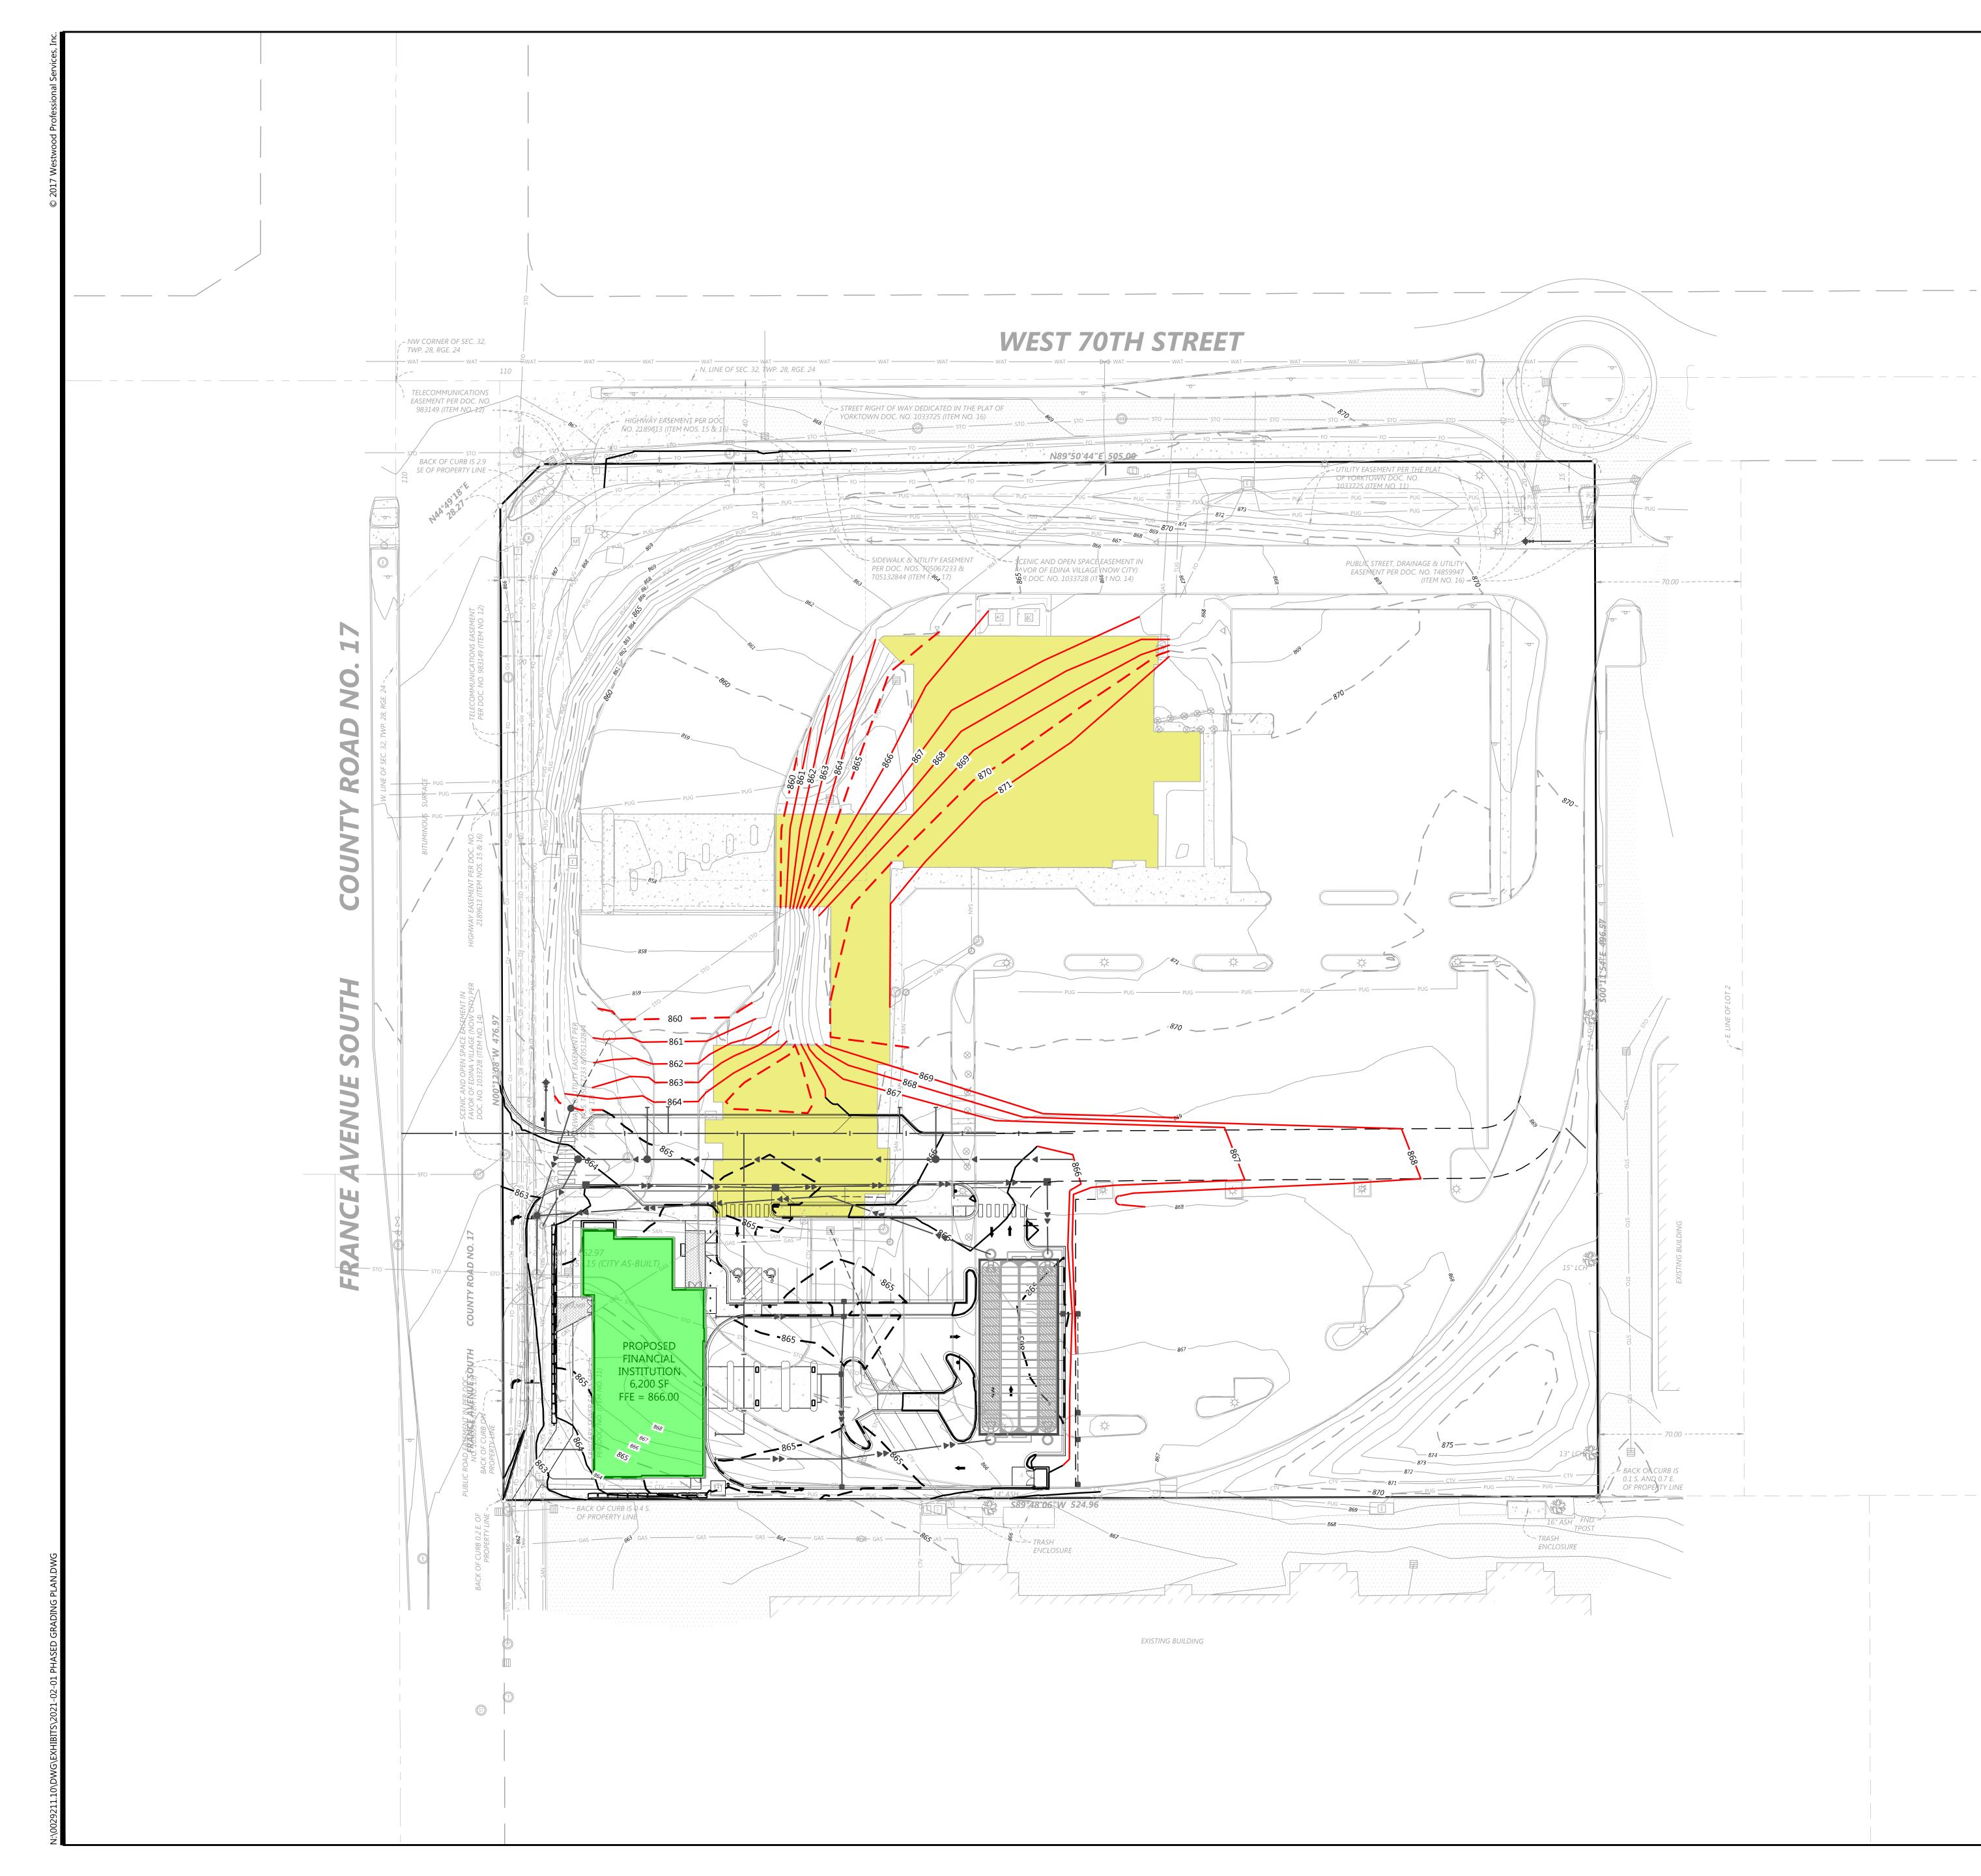


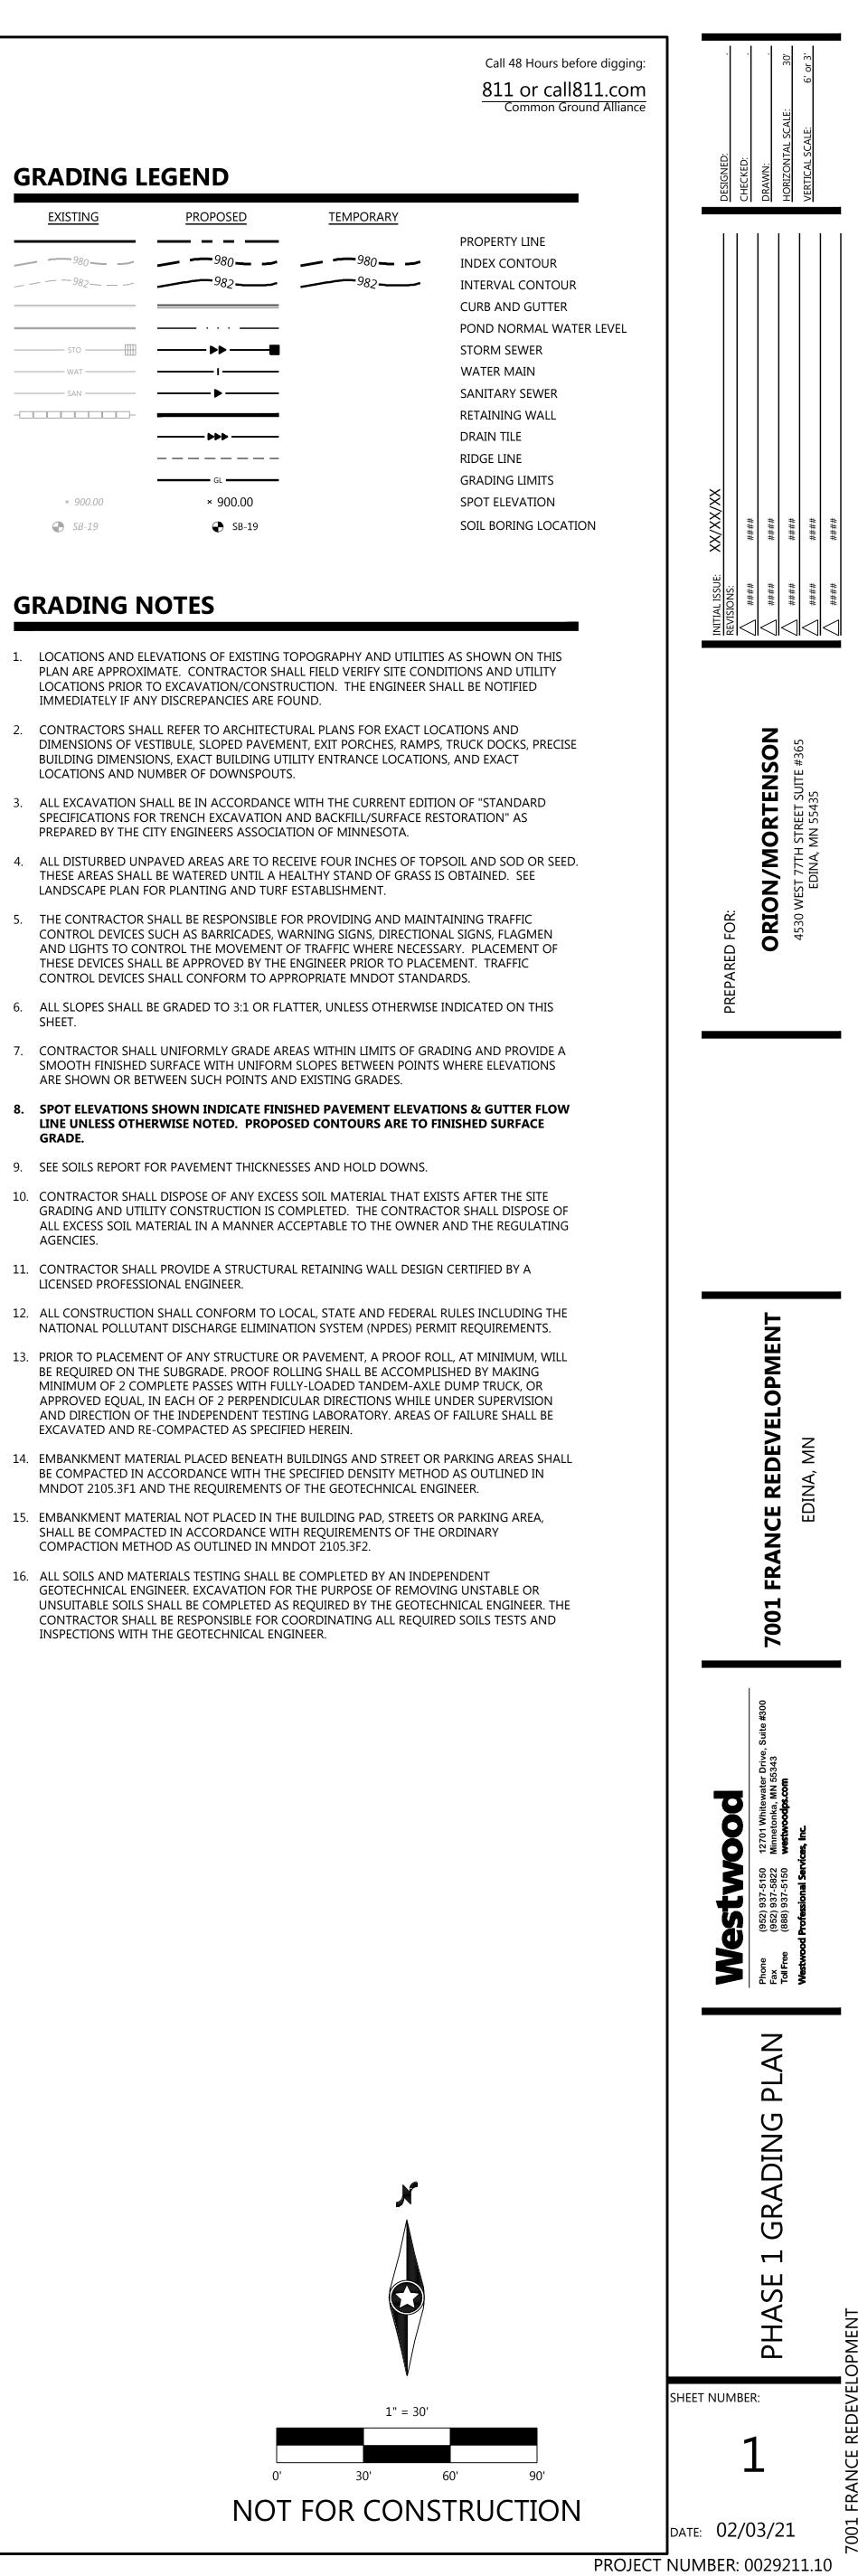


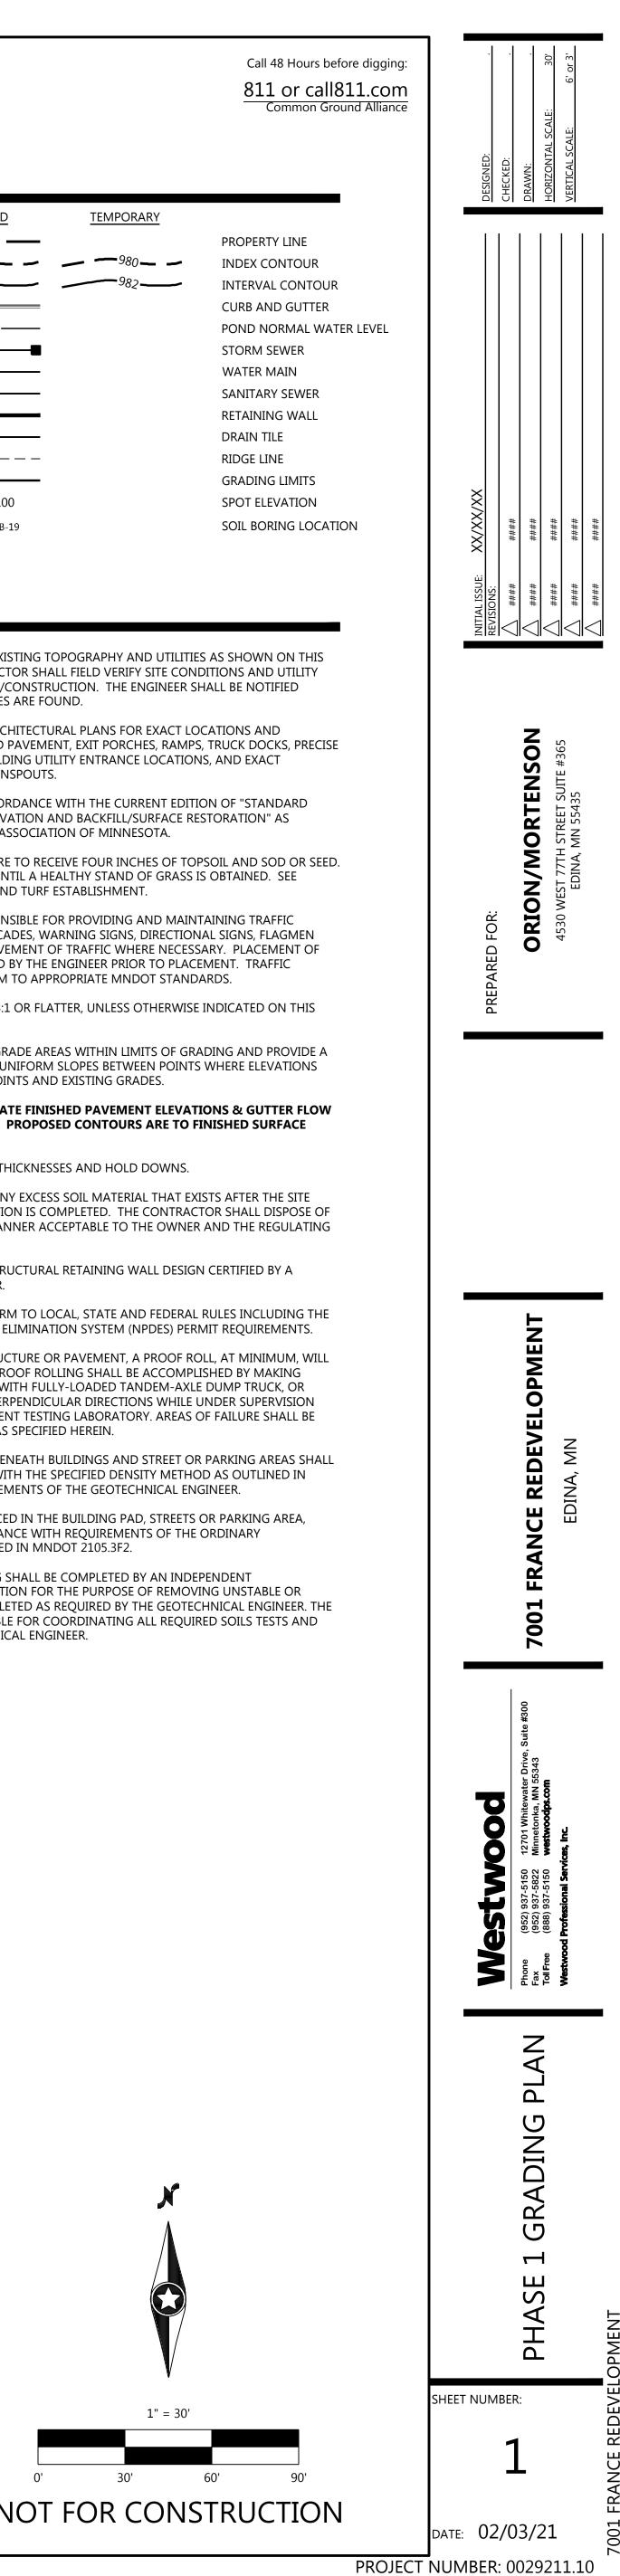

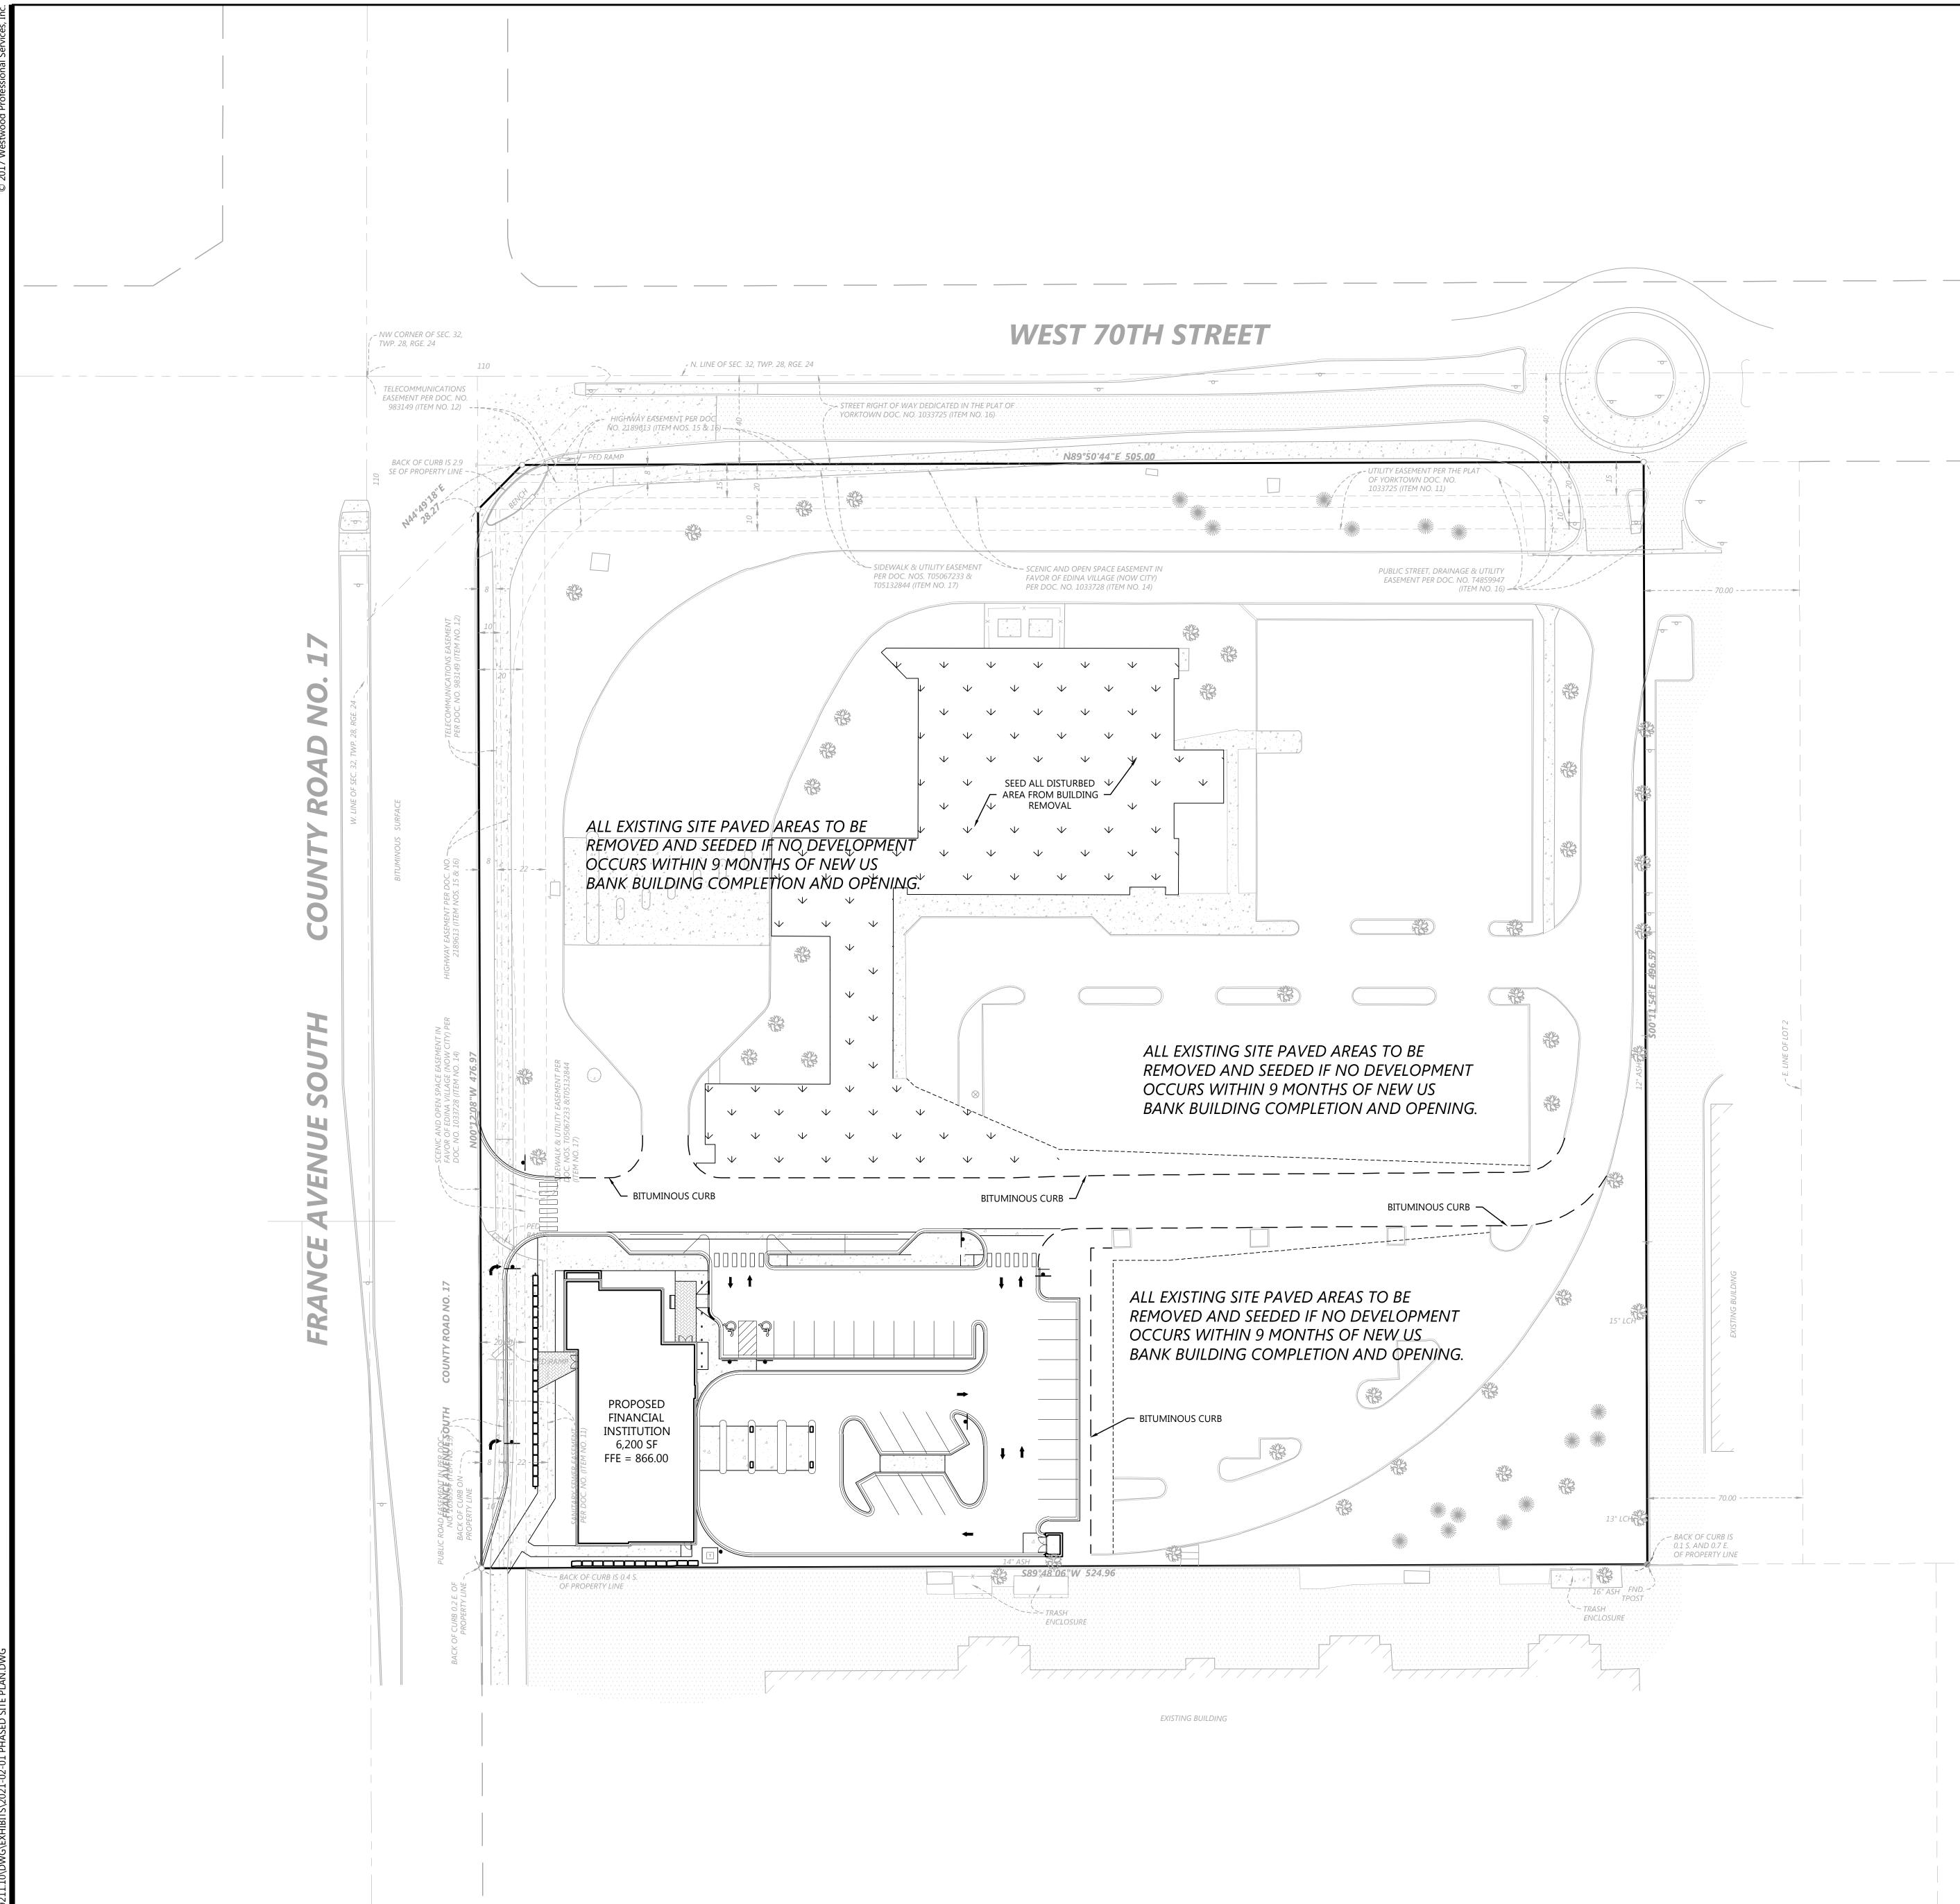

SITE LEGEND

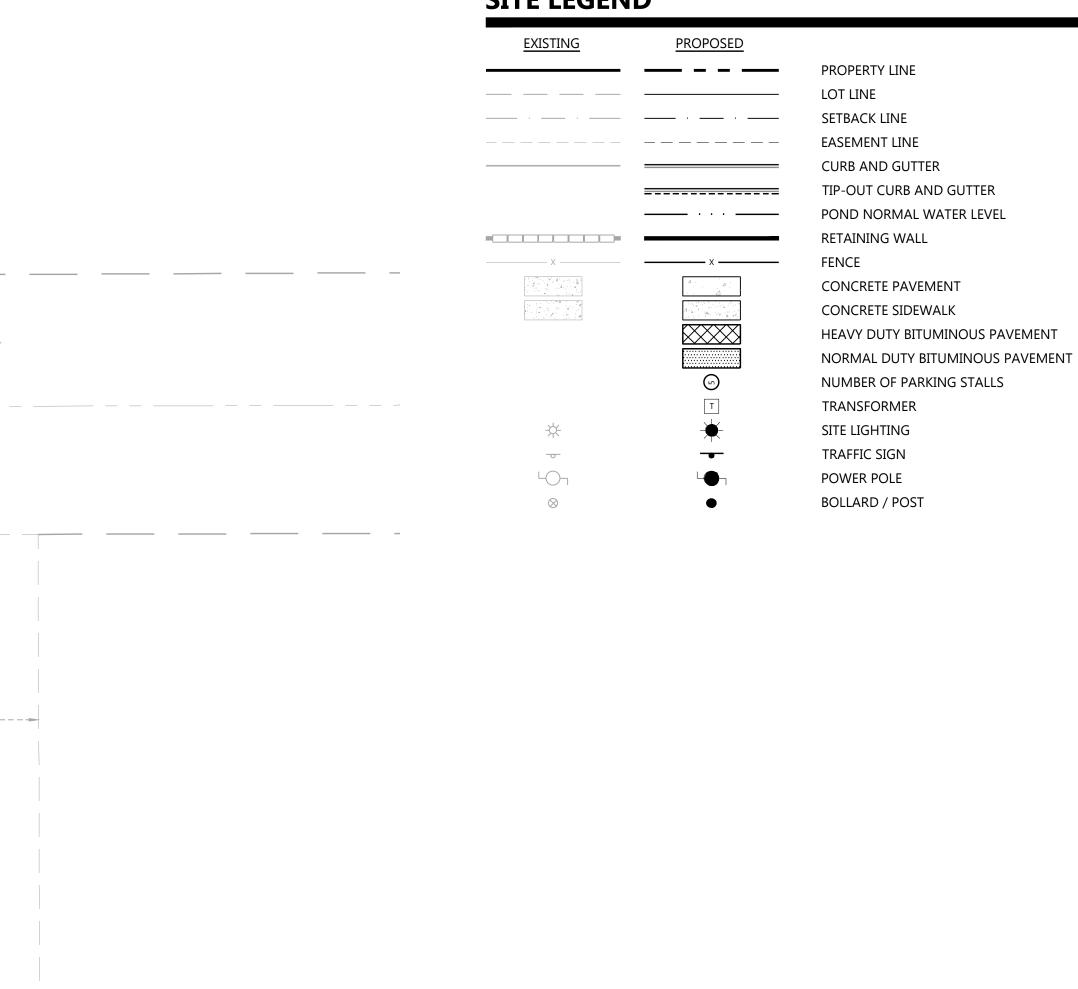

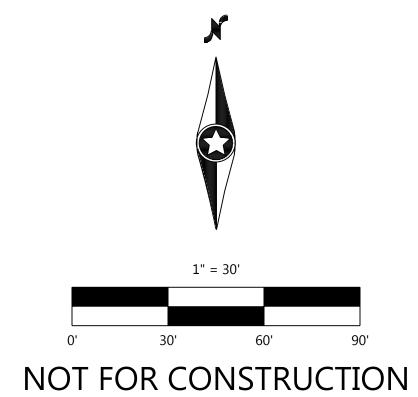

Call 48 Hours before digging: 811 or call811.com

